## THE CITY OF BRYAN, TEXAS

Plans to Serve

## BCS CHURCH OF CHRIST 10975 STATE HIGHWAY 30 BRYAN, TEXAS

#### OWNER


BCS Church of Christ Dinc McDonald, Representative 11914 SH 30 College Station, Texas 77845 P: 979.774.7470

#### ARCHITECT

Schwarz-Hanson Architects 2627 Tillar Street; Suite 137 Fort Worth, Texas 76107 P: 817.377.3600

#### SURVEYOR

Tumlinson Land Surveying Tyler Tumlinson, RPLS #6410 PO Box 633 Millican, Texas 77866 P: 254.931.6707

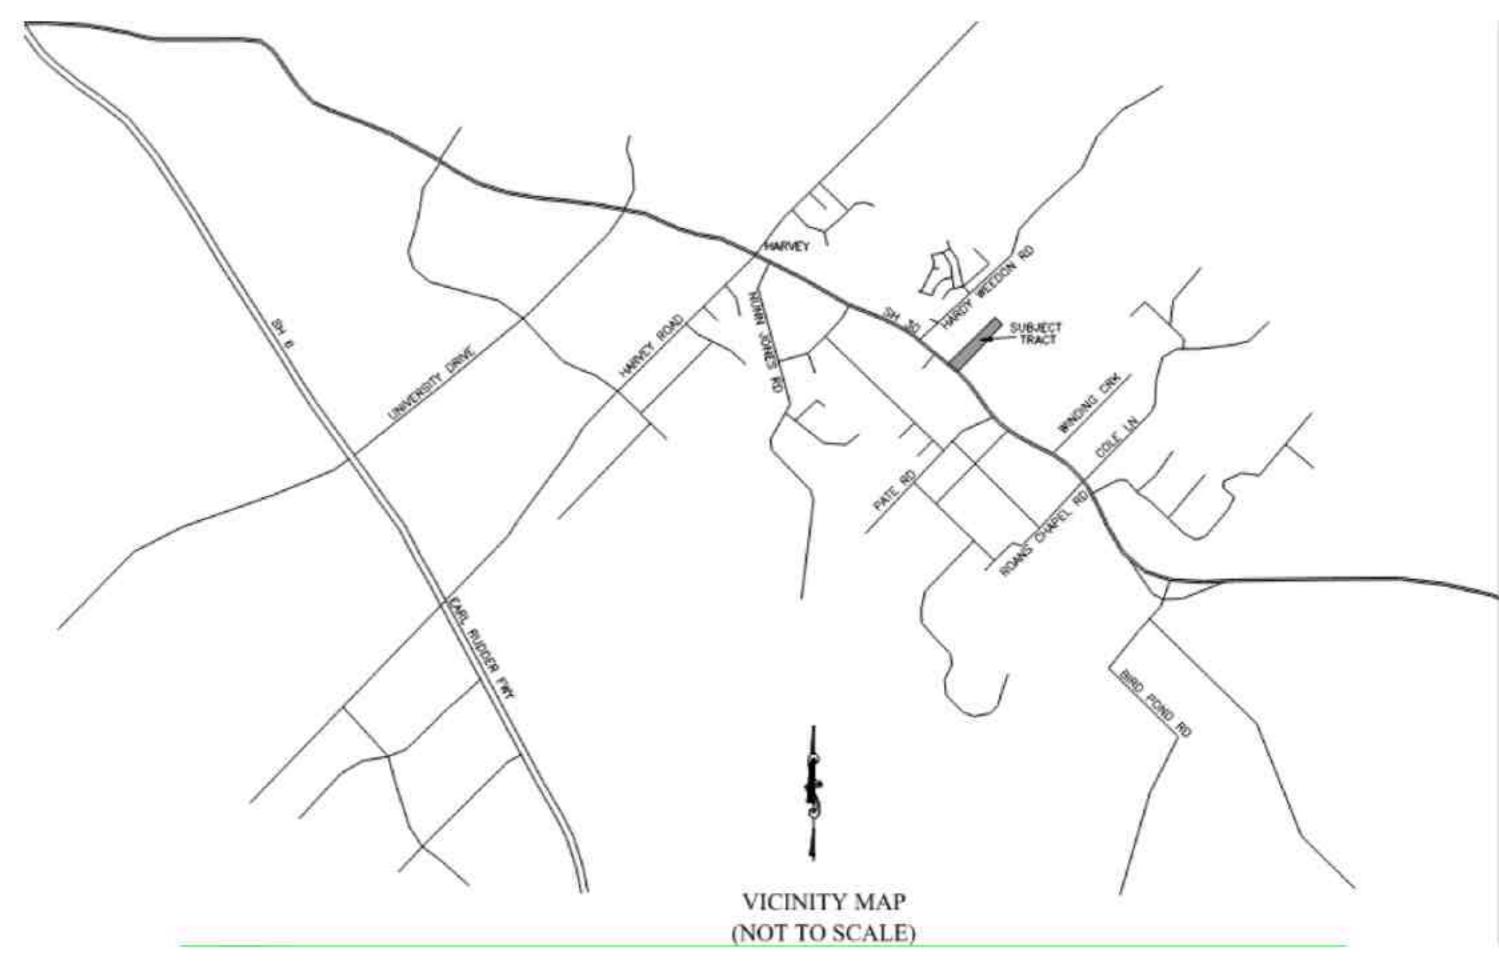

## LOCATION MAP



#### SHEET NO

#### DESCRIPTION

1. CO.O COVER SHEE

3. C2.0 TXDOT PERMIT PLA

C4.0 PAVING PLA

5. C4.0 DETAILS

6. C4.1 GENERAL CONSTRUCTION NOTES

CO. DRAINAGE DI

C7.0 UTILITY DI ANI

10 CR 0 FROSION CONTROL F


11. C8.1 EROSION CONTROL DETAILS


OFFY APPROVAL

OFFY APPROVAL

DATE

NOTE TO PROSPECTIVE BIDDERS:
ALL PROSPECTIVE BIDDERS SHALL VISIT
THE SITE AND BECOME FAMILIAR WITH
THE SITE PRIOR TO SUBMITTING A BID.

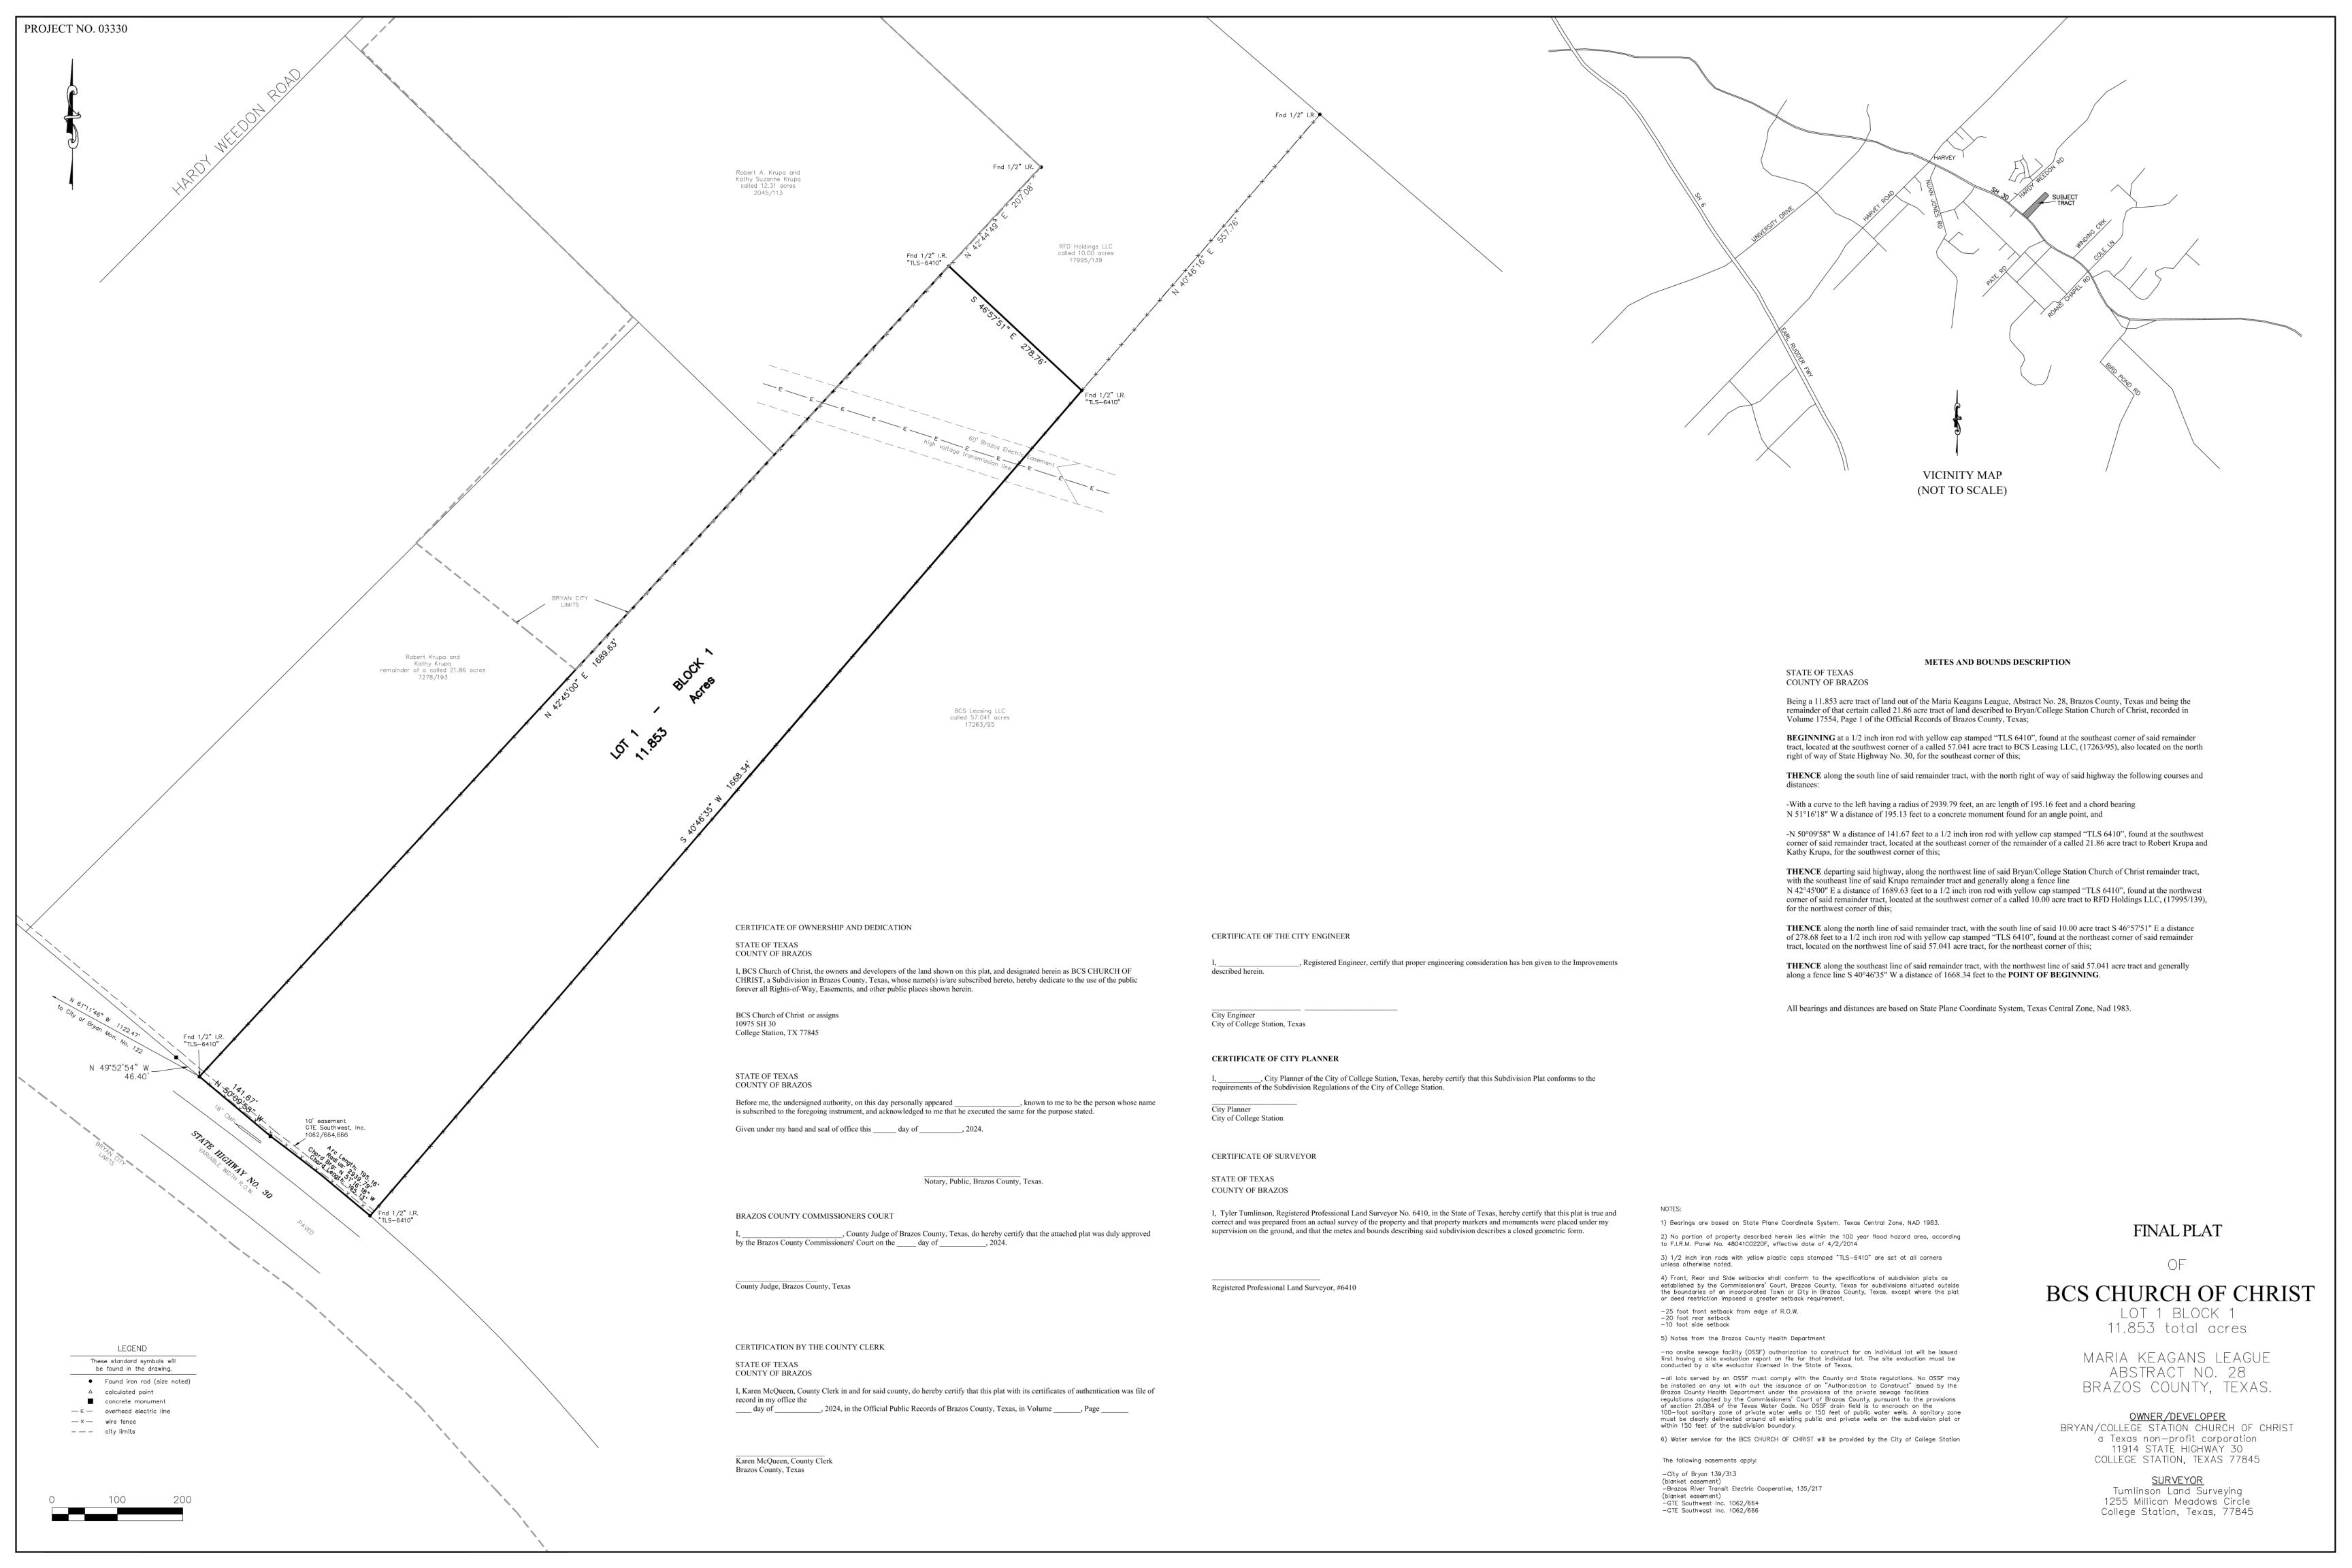

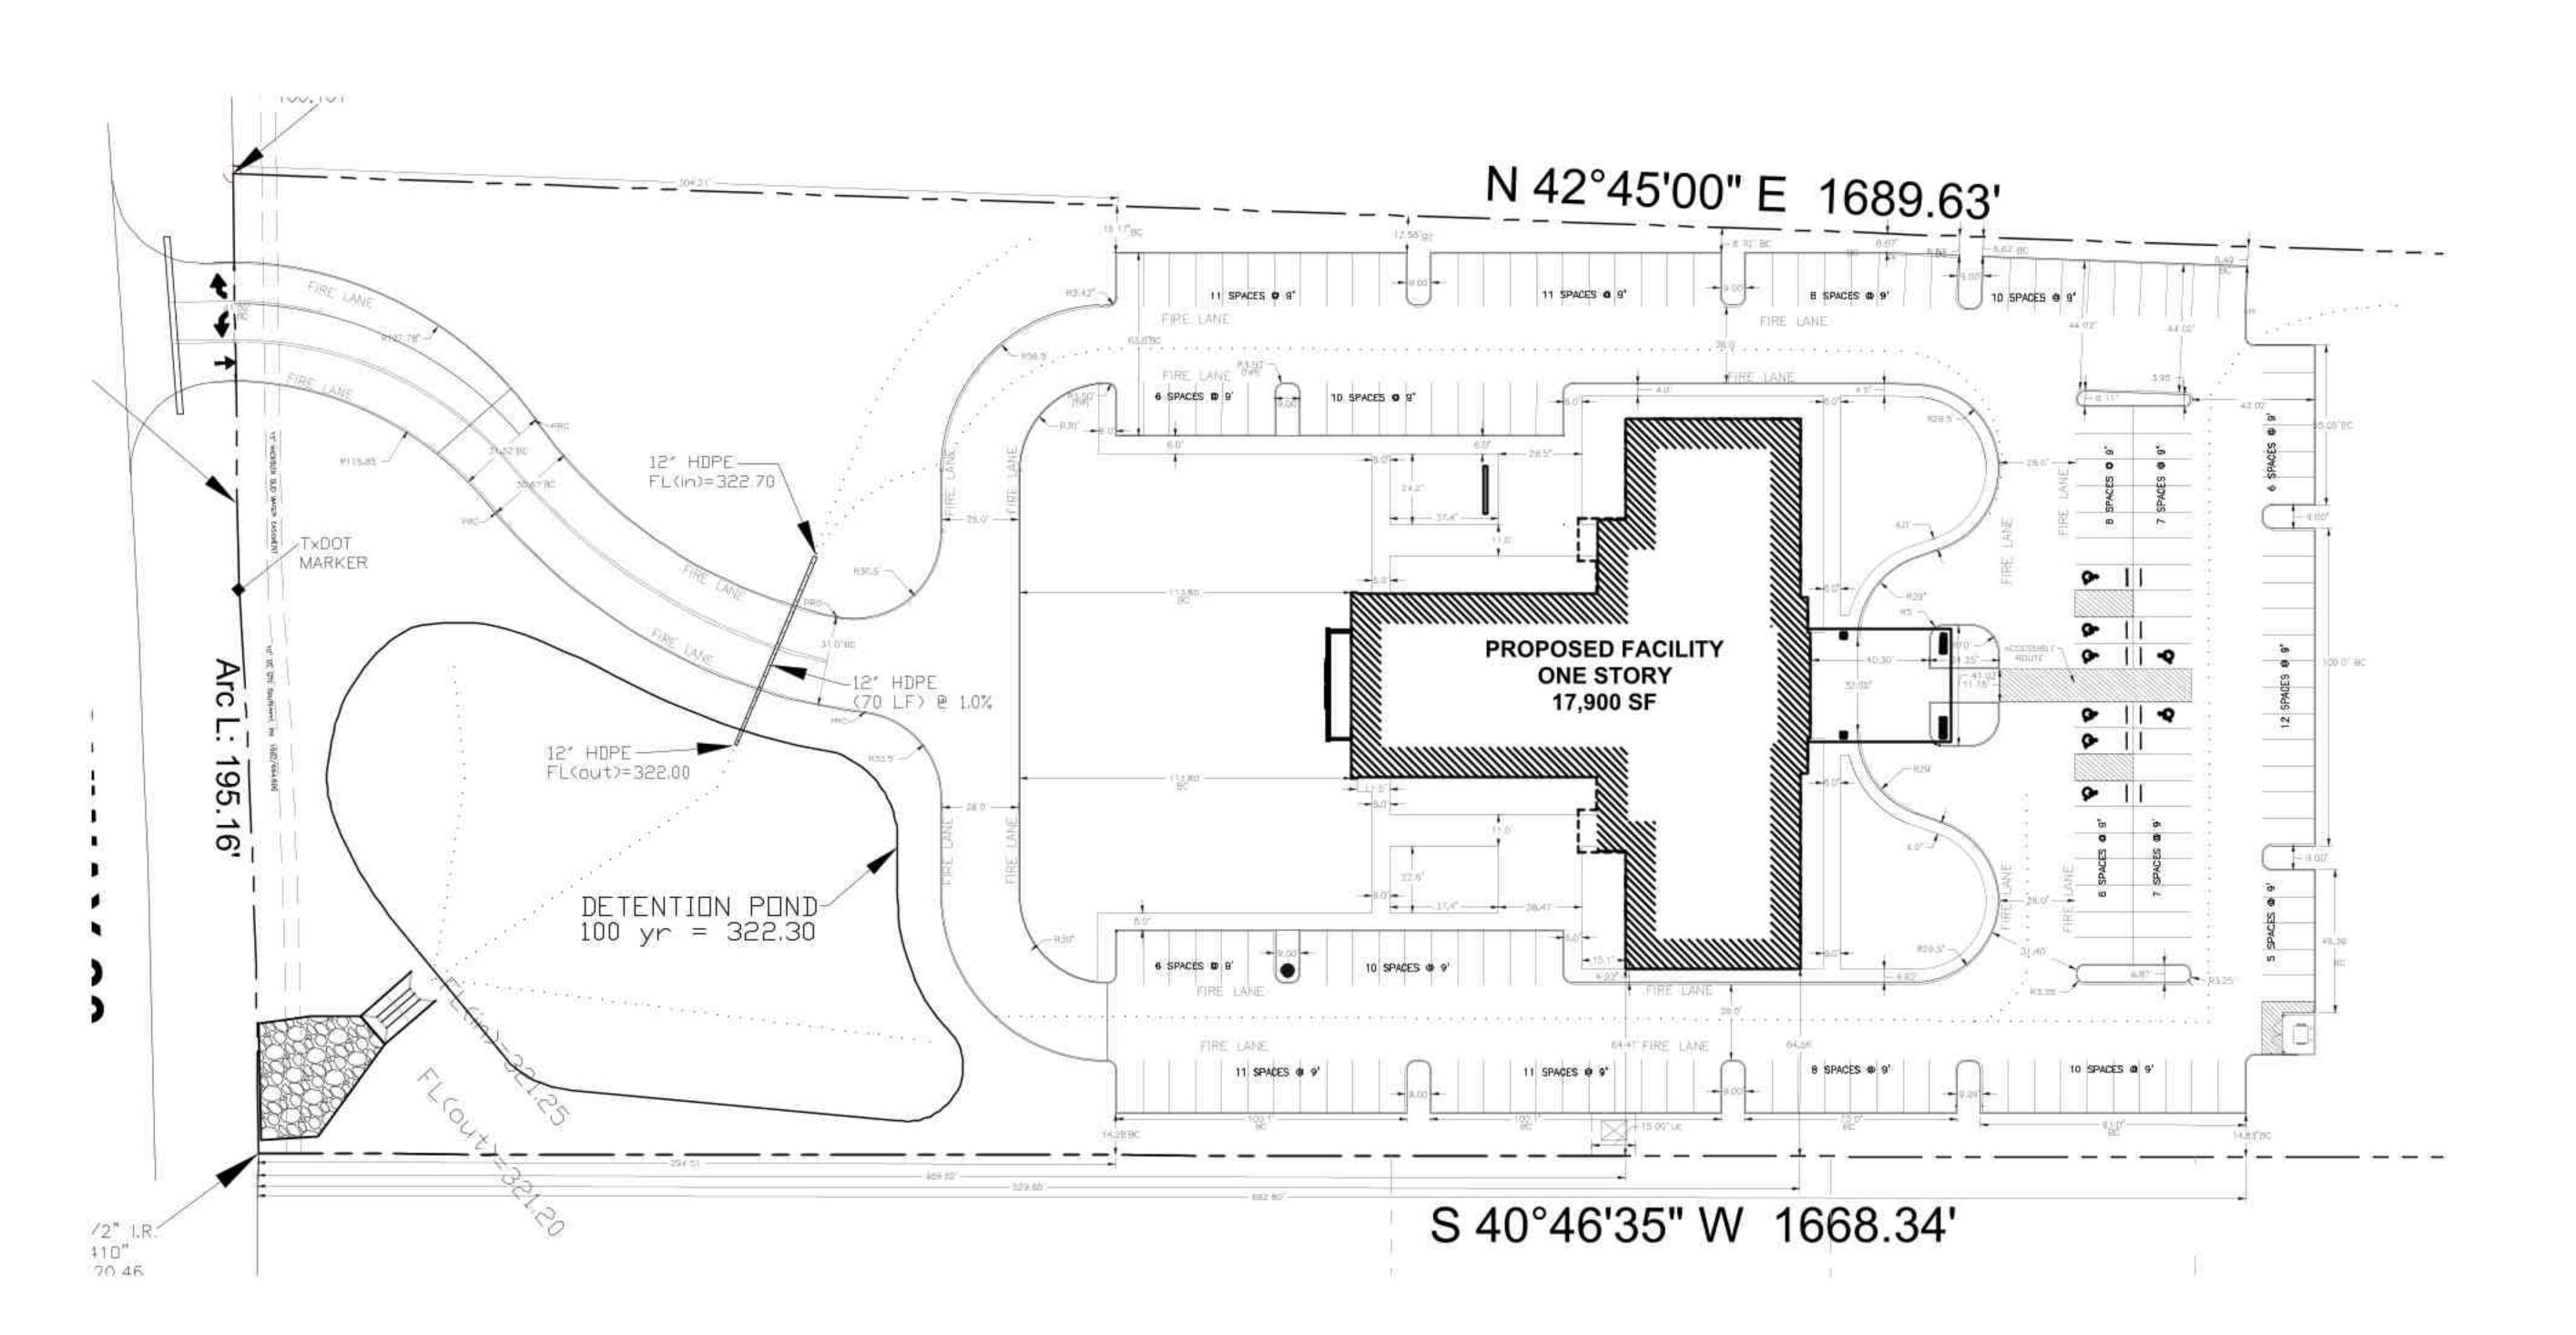

NOTE:

1. DIMENSIONS TO FACE OF CURB OR FACE OF WALL UNLESS OTHERWISE NOTED.

REFER TO ARCHITECTURAL PLANS FOR BUILDING/FOUNDATION DIMENSIONS.

REFER TO LANDSCAPE PLANS FOR IRRIGATION AREAS.

 DIMENSIONS TO PROPERTY LINE ARE PERPENDICULAR TO PROPERTY LINE UNLESS OTHERWISE NOTED.

 ALL ISLANDS TO BE 9' IN WIDTH FROM FACE OF CURB UNLESS OTHERWISE NOTED..

 ISLAND RADIUS'S AND PARKING SPACE RADIUS'S TO BE 3.5' TYPICAL UNLESS OTHERWISE NOTED. ACCESIBLE ROUTE NOTE:

 ACCESSIBLE ROUTE SHALL BE BE PAINTED (RE: C3.0).


 "NO PARKING" STRIPING AND HANDICAP AREAS STRIPING SHALL BE PAINTED "HANDICAP" BLUE.

DRIVE APPROACH NOTE:

1. A PRELIMINARY DRIVE APPROACH HAS BEEN

APPROVED BY TXDOT.

2. THE CONTRACTOR SHALL BE RESPONSIBLE FOR SUBMITTING AND OBTAINING THE FINAL PERMIT FOR CONSTRUCTION.

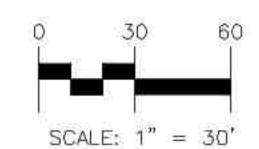

DIMENSION CONTROL

THE CONTRACTOR SHALL NOTIFY THE FOLLOWING GOVERNMENTAL AND/OR UTILITY COMPANIES REGARDING THE LOCATION OF EXISTING FACILITIES PRIOR TO CONSTRUCTION.

WICKSON CREEK SUD (WATER): CITY OF BRYAN BUILDING AND PERMIT INSPECTIONS; CITY OF BRYAN ENGINEERING: BRAZOS ELECTRIC COOPERATIVE (ELECTRICAL SERVICE)

ALL OTHERS:

979-219-7814 XXX-XXX XXX-XXX XXX-XXX XXX-XXX 817-377-3600 mail@schwarz-hanson.com

ARCHITECTS

2627 TILLAR STREET, SUITE 131 FORT WORTH, TX 76107

AXIOM MANAGEMENT & ENGINEERING, INC.
P.O. BOX 8460
FORT WORTH, TEXAS 76115

FORT WORTH, TEXAS 76115 (817) 994-5420 FIRM #: F-3654

A NEW FACILITY FOR

CHURCH OF CHRIST

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> SCOTT ATWOOD, PE REG.# 70851


REVISION SCHEDULE							
#	Description	Date					
	Initial	01-19-2024					
1	Revise SS alignment to back	02-16-2024					
2	City Submittal	02-21-2024					

SHEET NAME

SITE PLAN (CIVIL)

SHEET NO.

C1.0

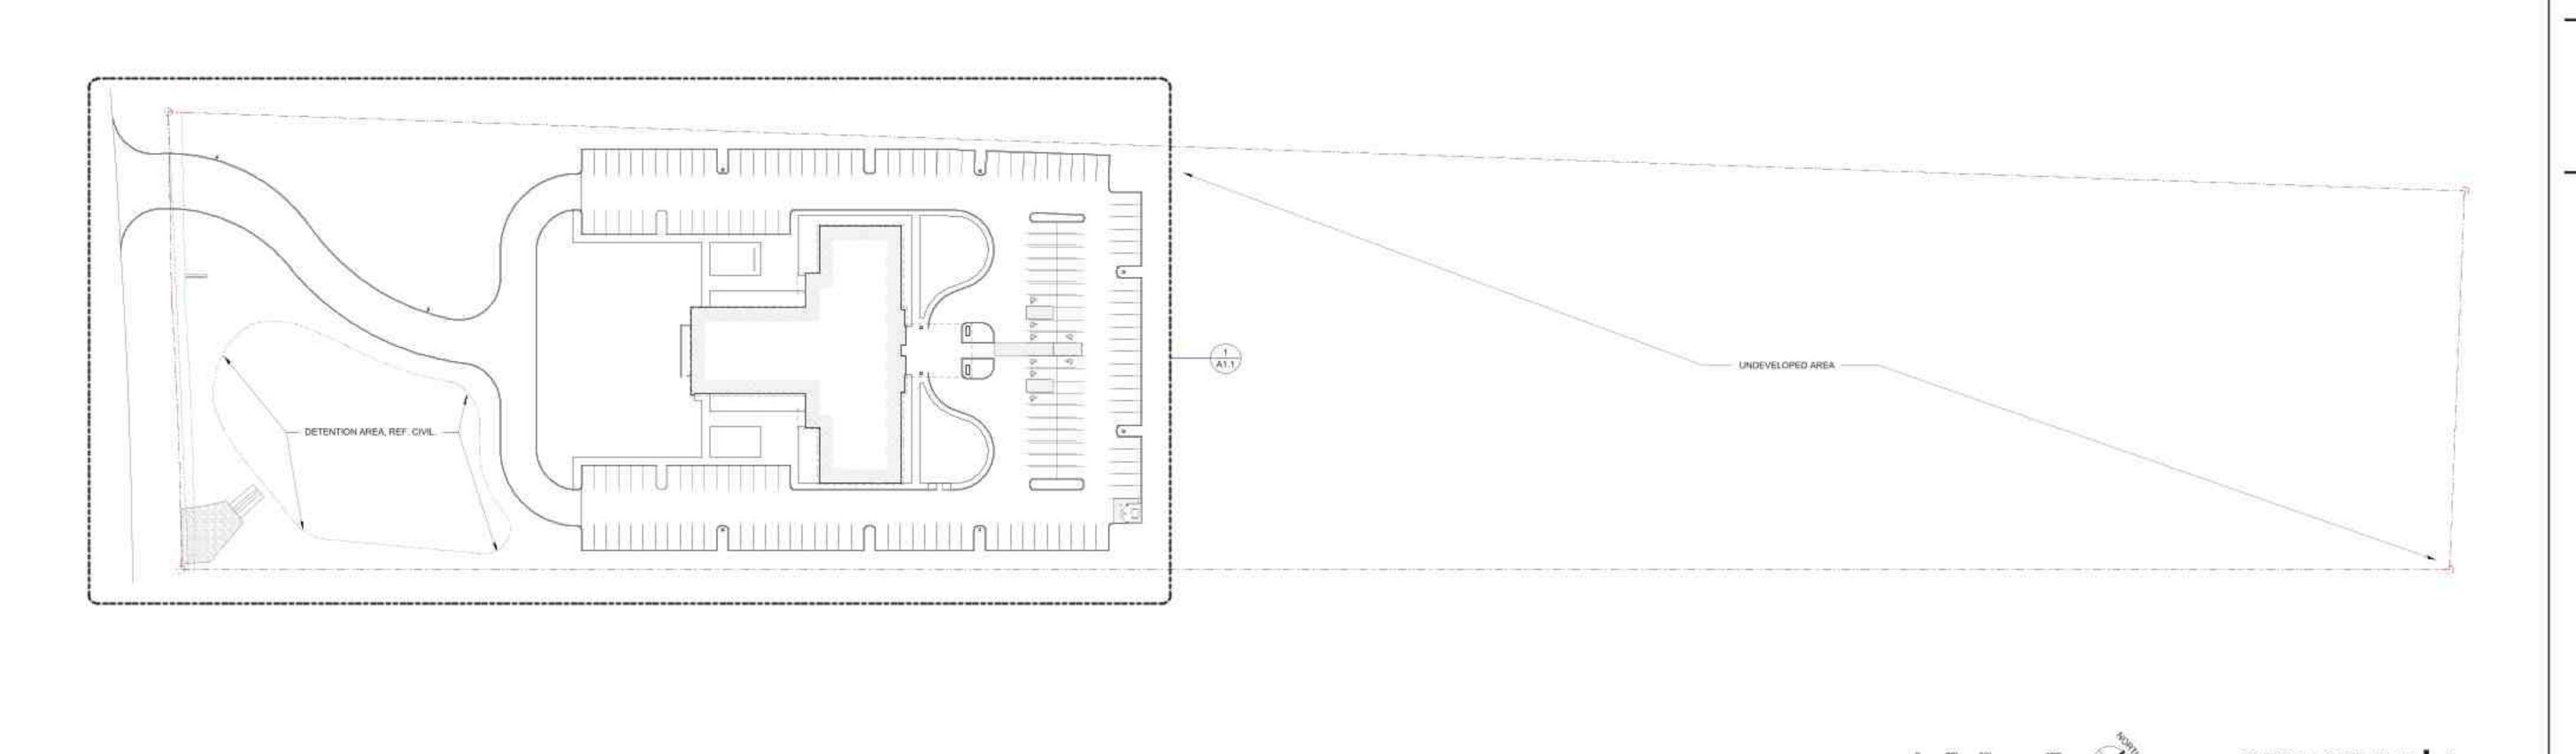

PARKING SUMMARY

TOTAL ACCESSIBLE PARKING REQUIRED:

TOTAL ACCESSIBLE PARKING PROVIDED:

TOTAL PARKING REQUIRED: ONE PER 3 SEATS AT 520 SEATS

TOTAL PARKING PROVIDED

TAG SIZE

LO +3.0" CALIFER

CF 1.5" - 3.0" CALIPER

MB 1.5" - 3.0" CALIPER

CV 15 - 3.0 CALIPER

RY 2-15-GAL

TB 2-15 GAL

GM 2-15 GAL

AS 2-15 GAL

BG COVER

GRAND TOTAL

LANDSCAPE REQUIREMENTS

TOTAL AREA REQUIRED: 12,519 SF

LANDSCAPED AREA PROVIDED: 12,528 SF

ALL PARKING ISLANDS MUST HAVE A CANOPY TREE

LANDSCAPE TABLE

OFFICIAL NAME

Quercus Virginiaria

Pistocia Chinensis

CHINESE PISTACHE

MEXICAN BUCKEYE

Опривожа Брескови

Vitex Agrus-Cautus

Himperatoe Parvillora

Muhiusbergia Capitaria

AUTUMN SAGE

Salvin greggo

BERMUDA Cynedon Dactylon

TEXAS SAGE THUNDERCLOUD!

Laucophyloni candidum 'Thurster Cloud'

15% OF DEVELOPED AREA (BUILDING AREA + PARKING AREA) 63,460 SQ FT = 12,516 SF LANDSCAPING

NOT LESS THAN 50% OF REQUIRED AREA SHALL BE TREES: 6,260 SF REQ'D; 8,050 PROVIDED NOT LESS THAN 50% OF TREE PLANTED SHALL BE CANOPY; 4,525 SF REQ'D; 8,050 PROVIDED

RED YUCCA

CHASTE TREE - VITEX

CANORY

NON/CANOPY

NON-CANOPY

SHRUB/ORASSES


SHRUB/CRASSES

SHRUB/GRASSES

BERMUDA

SHRLIB/OHASSES 40

LIVE DAK

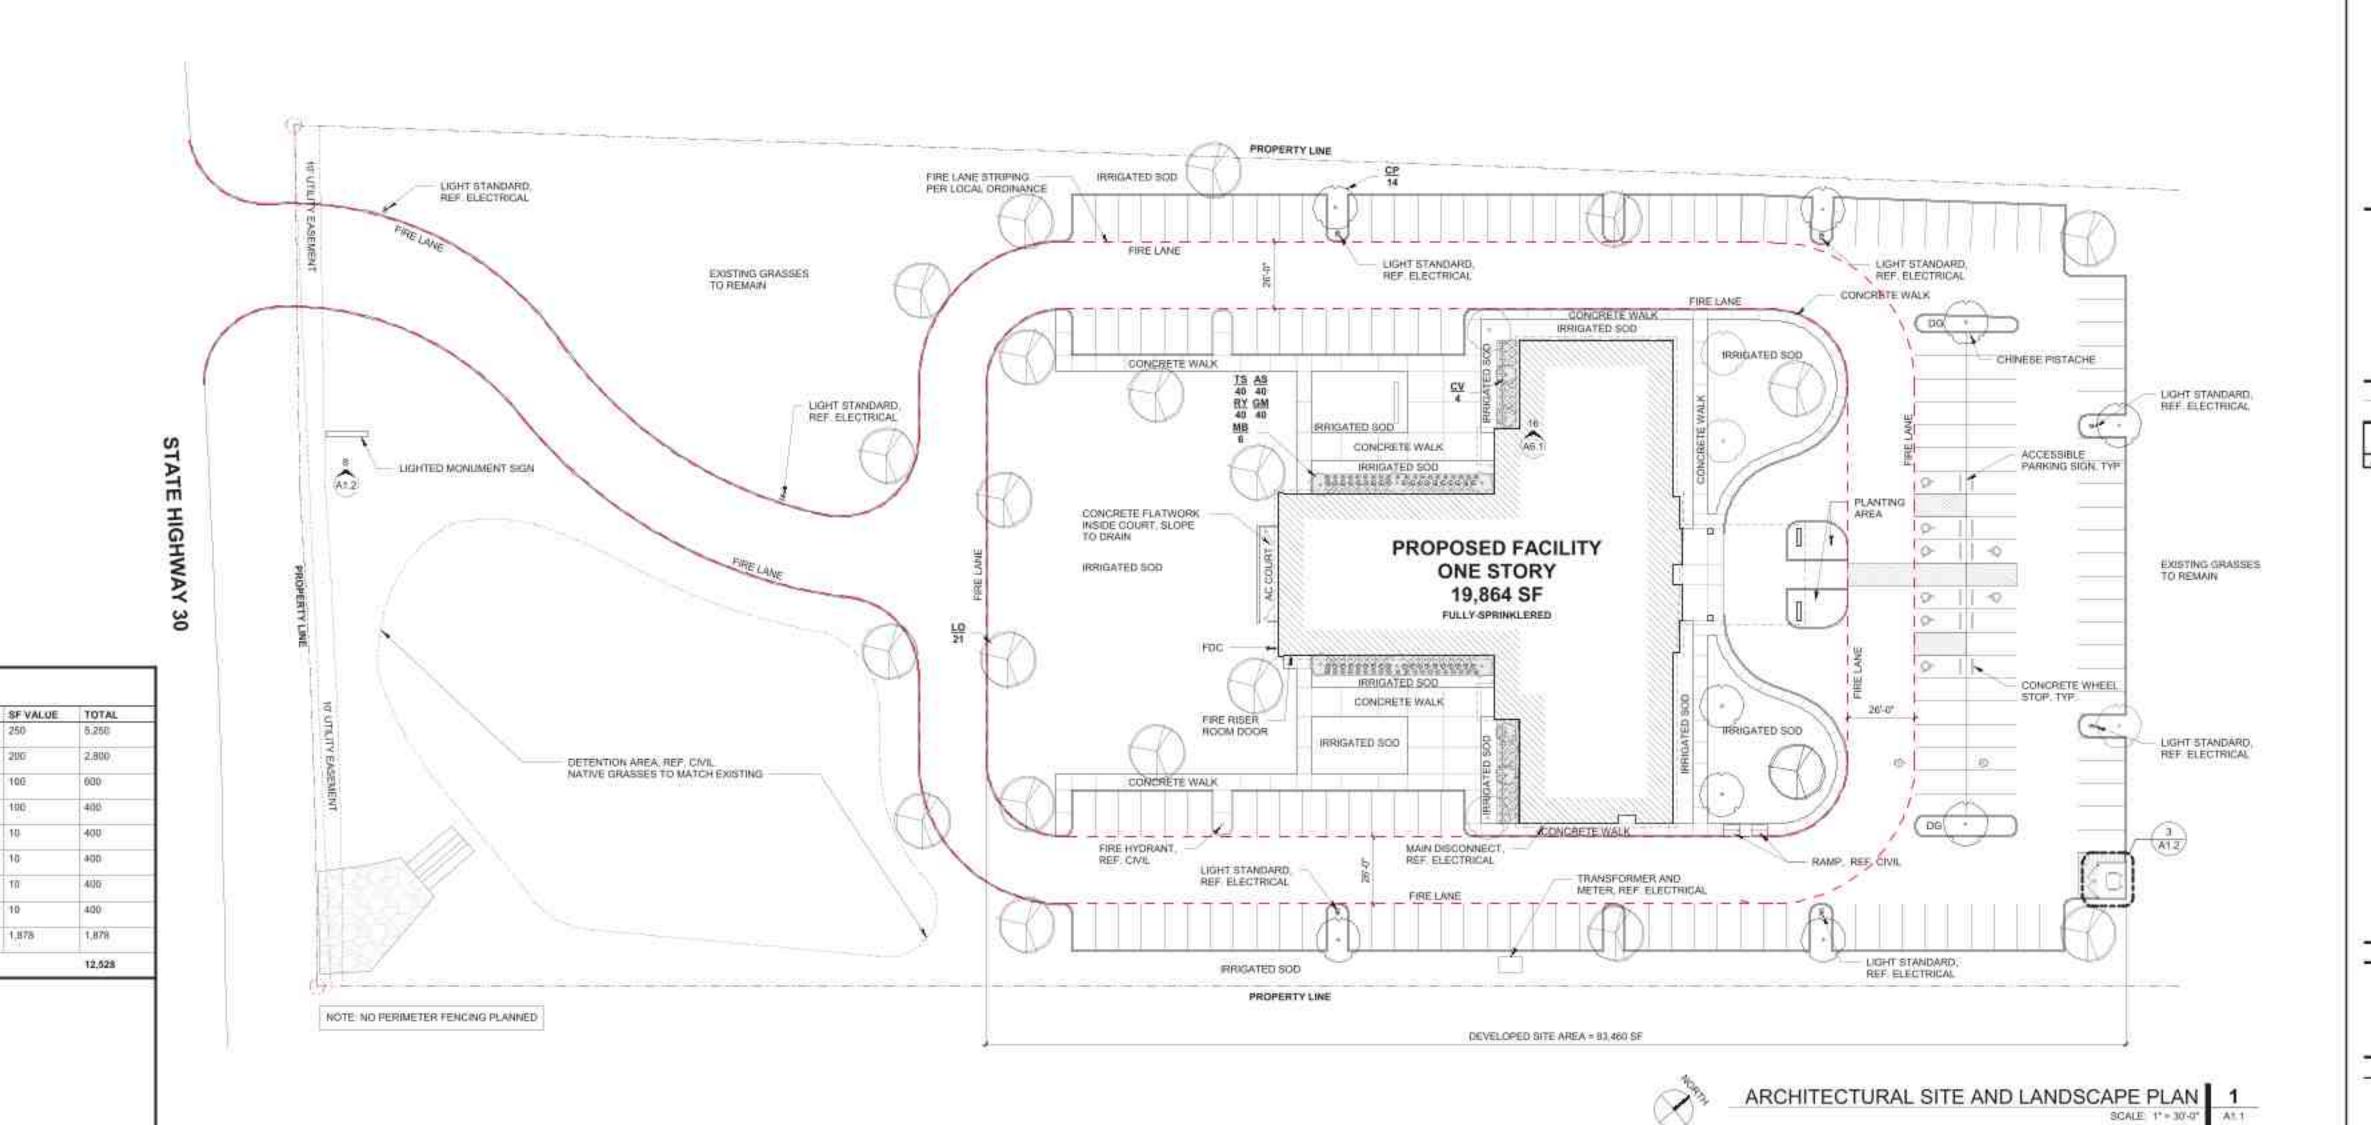

SCHWARZ
HANSON
ARCHITECTS

2827 TILLAR STREET, SUITE 131
FORT WORTH, TX 76107

FORT WORTH, TX 76107 817-377-3608 mab@actiwarz-transon.com

A NEW FACILITY FOR CHURCH OF CHRIST



DATE: 01-25-2024

REVISION SCHEDULE

Description Description

CARRIED MARKE

ARCHITECTURAL SITE AND LANDSCAPE PLAN

SHEET NO.

A1.1

PENALTY SIGN REQUIRED

STATE LAW TRC 681.011"

SCALE: 1/2" = 1'-0" A1.2

PAINTED CMU TO MATCH STONE COLOR, AS SELECTED

"PENALTY

\$250 TO \$500

ARCHITECTS

2627 TILLAR STREET, SUITE 131 FORT WORTH, TX 76107 817-377-3600 mail@schwarz-hanson.com © SCHWARZ-HANSON LTD.



PROJECT NO.: 23166 DATE: 01-25-2024

**REVISION SCHEDULE** 

SHEET NAME

SITE DETAILS

SHEET NO.

— 1/4" GALV. STEEL — PLATE CAP, CONTINUOUS WELD GRIND SMOOTH - FASTENER, TYP. OF 4 -PENALTY SIGN REQUIRED -"PENALTY \$250 TO \$500 STATE LAW TRC 681.011" — 12"x18" ACCESSIBLE — PARKING SIGN 0.63 ALUMINUM, REFLECTIVE 1'-4" WHITE LINES AND SLOPE SLOPE LETTERING ON REFLECTIVE BLUE FIELD, HIGH INTENSITY PRISMATIC, MIN. STEEL TUBESUPPORT VAN ACCESSIBLE -PARKING SIGN 8" CMU, FULLY GROUTED, ALUMINUM WHERE APPLICABLE PARKING SIGN 12"x2" GALV. STEEL ► FASTENER TUBE, PAINTED SPACER SURROUNDING GRADES - SHALL BE ABOVE CONC. CONCRETE FOUNDATION, PARKING SIGN DETAIL 5 ACCESSIBLE PARKING SIGN 2

SCALE: 6" = 1'-0" A1.2

PRE-FINISHED METAL CAP

8" CMU, BLOCK FILLER AND

PAINT EXPOSED FACE,

CONCRETE SLAB, REF.

- CONCRETE FOUNDATION,

SITE PAVING, REF. CIVIL

REF. STRUCTURAL

STRUCTURAL

REF. STRUCTURAL

16'-0" LETTERS. SIGNAGE SHALL INCLUDE 15'-6" BUILDING ADDRESS IDENTIFICATION NUMBER PER CODE. CONTRACTOR DESIGN, FABRICATE, INSTALL, AND CHURCH OF STONE BASE TO MATCH BUILDING -

SIGN SECTION 1

CAST STONE CAP, DOUBLE SLOPE

STONE VENEER -

REF. STRUCTURAL

SIGNAGE GRAPHICS

REF. STRUCTURAL

TWO SIDED, METAL PANEL COVERED SIGN BOX W/ LIGHTED

TO ASSIST OWNER IN RETAINING SIGN COMPANY TO FINALIZE SIGN

MEETING TIMES AND ADDRESS -

SURROUNDING GRADES SHALL BE ABOVE CONC. FOUNDATION

CONCRETE FOUNDATION,

REF. STRUCT.

PERMIT.

BY OWNER

FOUNDATION

WITH RETURN ENDS

MONUMENT SIGN 8

SCALE: 1/4" = 1'-0" A1.2

DUMPSTER ENCLOSURE 6

SCALE: 3/4" = 1'-0" A1.2

DUMPSTER ENCLOSURE ENLARGED PLAN SCALE: 1/4" = 1'-0" A1.2

DUMPSTER

BY OWNER

11'-4"

1'-0" 7 5/8"

A1.2

COORDINATE UTILITIES TO MONUMENT SIGNAGE, REF. ELECTRICAL 2'-0" STONE VENEER DOUBLE WYTHE 8" CMU, FULLY GROUTED, REF. STRUCTURAL SURROUNDING GRADES SHALL BE ABOVE CONC. FOUNDATION CONCRETE FOUNDATION, REF. STRUCTURAL


TWO SIDED, METAL PANEL COVERED SIGN BOX W/ LIGHTED LETTERS. SIGNAGE SHALL INCLUDE BUILDING ADDRESS IDENTIFICATION NUMBER PER CODE. CONTRACTOR TO ASSIST OWNER IN


RETAINING SIGN COMPANY TO FINALIZE SIGN DESIGN, FABRICATE, INSTALL, AND PERMIT.

SIGNAGE GRAPHICS -BY OWNER

 MONUMENT SIGN
 4

 SCALE: 3/4" = 1'-0"
 A1.2

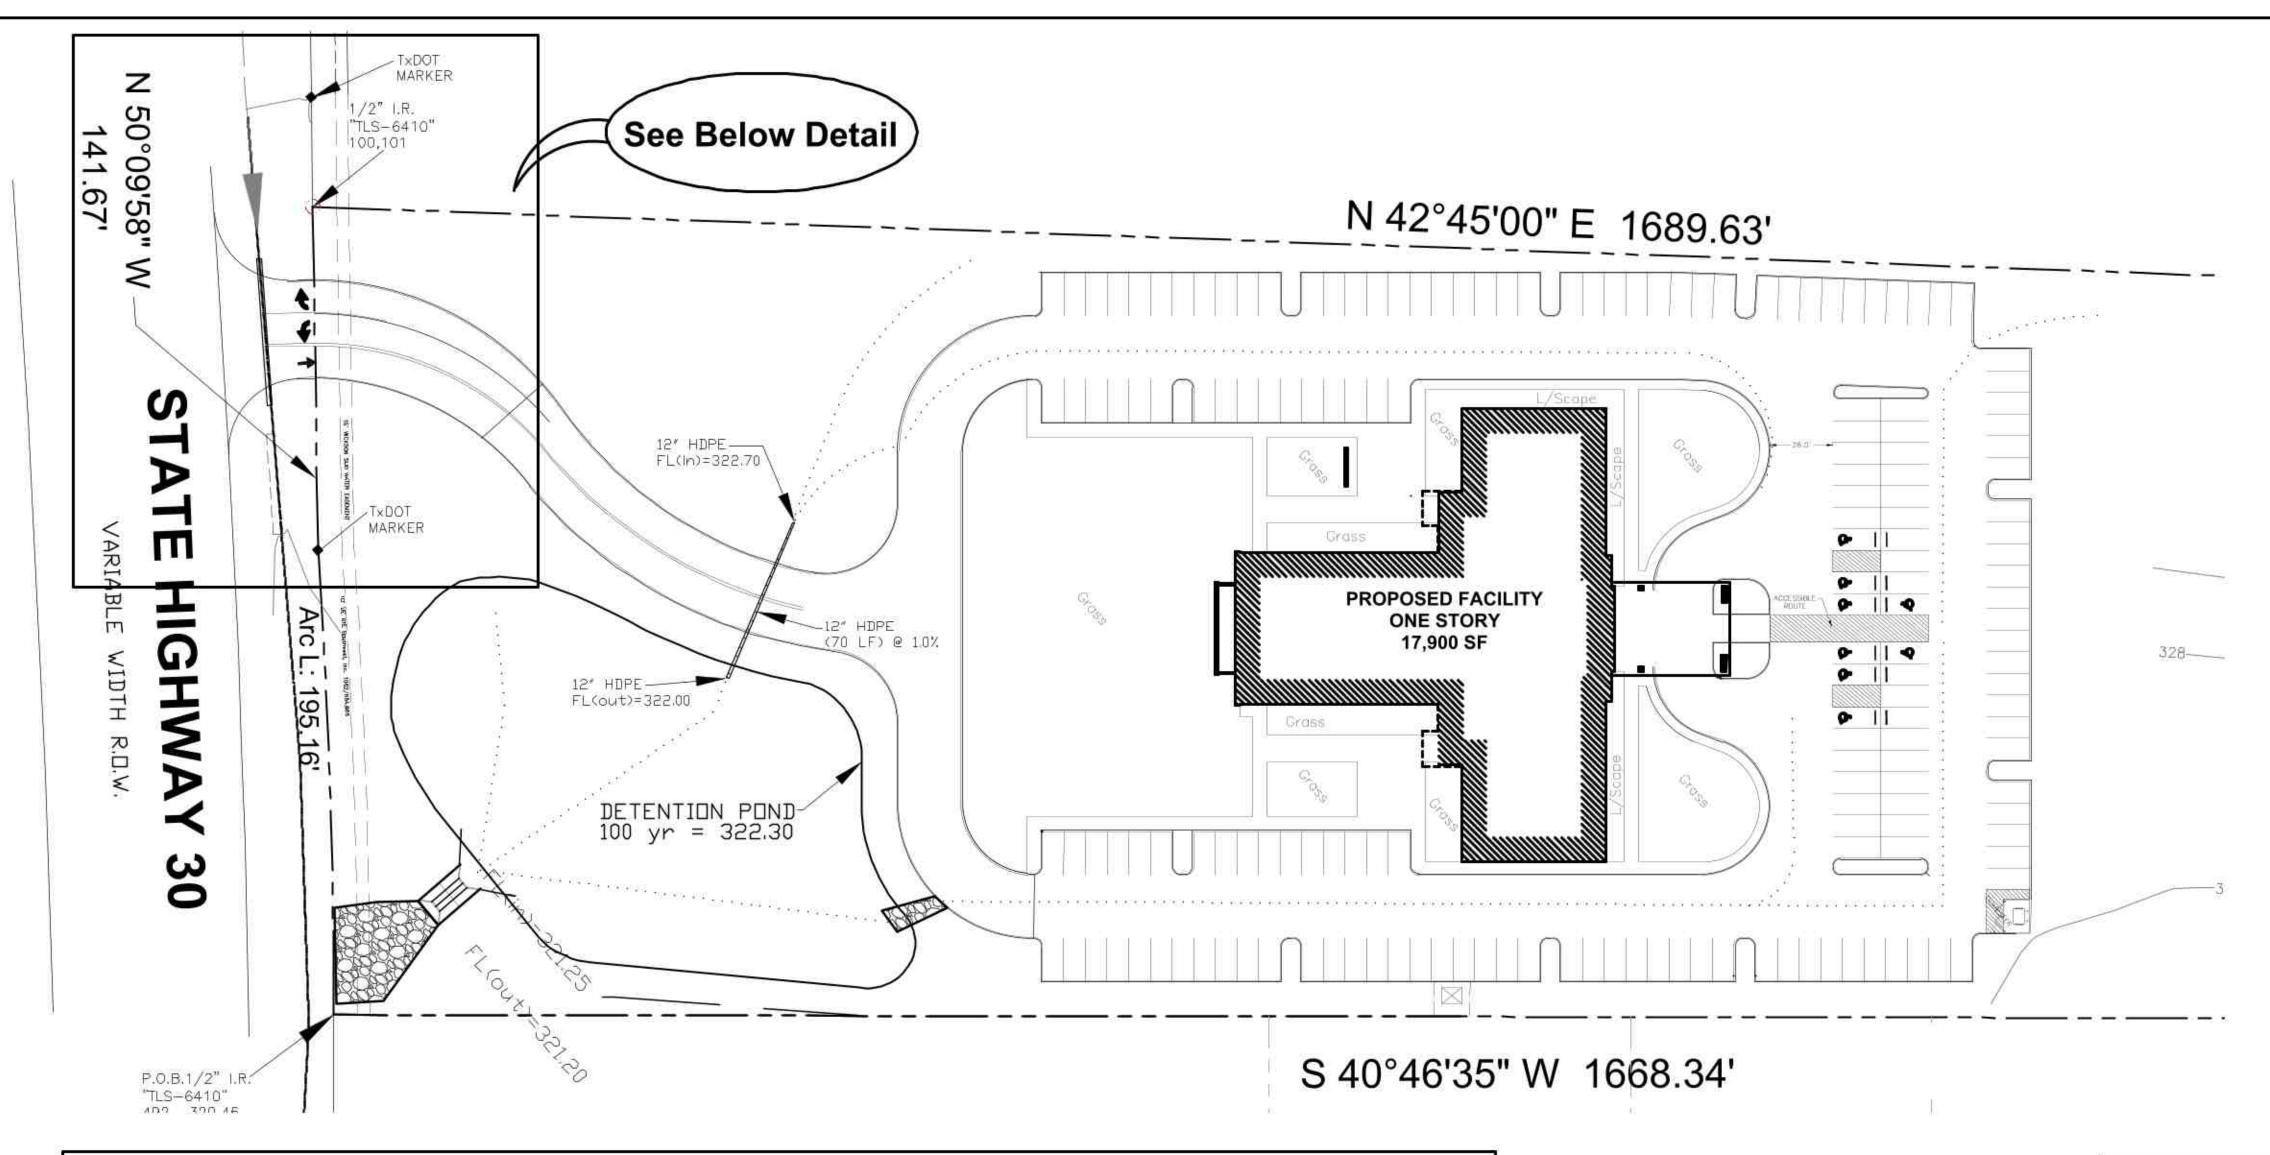

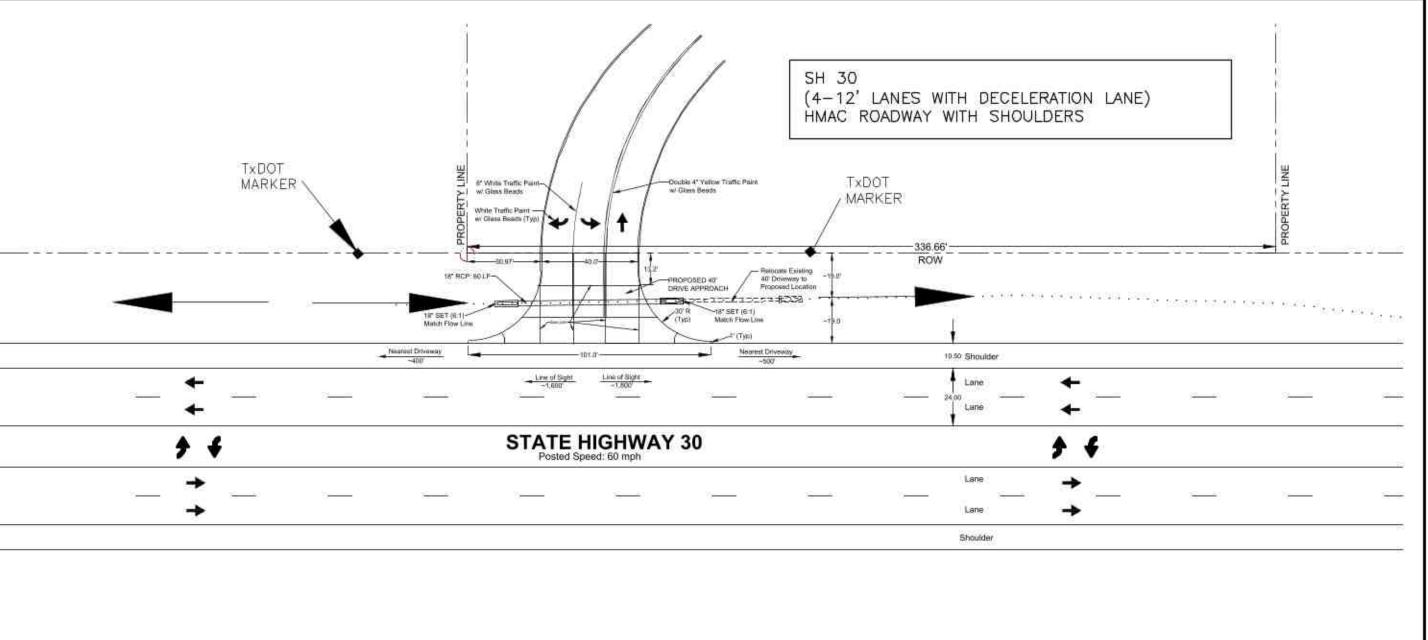

#### NOTES

- 1. Driveway to meet Texas Department of
- Transportation driveway design standards. Driveway shall be 3,000 psi concrete
- compressive strength @ 28 Days. 3. Concrete depth shall be 6".
- 4. Reinforcing steel shall be #4 on 12" centers
- 5. Drainage pipe shall be Reinforced Concrete Pipe (RCP) (Class III).
- 6. SET may be precast type of beveled pipe
- property corner.

#### REFERENCE STANDARD SHEETS

- \*TRAFFIC CONTROL PLAN SHEET TCP (2-1)-18
- \*WORKSHEET FOR EDGE CONDITION TREATMENT TYPES
- \*BARRICADE AND CONSTRUCTION STANDARD PLAN SHEET BC (1 of 12)-21
- \*BARRICADE AND CONSTRUCTION STANDARD PLAN SHEET BC (2 of 12)-21
- \*BARRICADE AND CONSTRUCTION STANDARD PLAN SHEET BC (3 of 12)-21 \*BARRICADE AND CONSTRUCTION STANDARD PLAN SHEET BC (4 of 12)-21
- \*BARRICADE AND CONSTRUCTION STANDARD PLAN SHEET BC (5 of 12)-21
- \*BARRICADE AND CONSTRUCTION STANDARD PLAN SHEET BC (6 of 12)-21
- \*BARRICADE AND CONSTRUCTION STANDARD PLAN SHEET BC (7 of 12)-21 \*BARRICADE AND CONSTRUCTION STANDARD PLAN SHEET BC (8 of 12)-21
- \*BARRICADE AND CONSTRUCTION STANDARD PLAN SHEET BC (9 of 12)-21
- \*BARRICADE AND CONSTRUCTION STANDARD PLAN SHEET BC (10 of 12)-21
- \*BARRICADE AND CONSTRUCTION STANDARD PLAN SHEET BC (11 of 12)-21
- 14. \*BARRICADE AND CONSTRUCTION STANDARD PLAN SHEET BC (12 of 12)-21

PLOT SIZE FOR CORRECT SCALE IS FOR A 22"x34". SHEET SIZE. THIS WILL REDUCE DOWN TO A SCALABLE HALF SIZE TO 11"x17". - SOME TxDOT

DISTRICTS REQUIRE THIS SHEET SIZE.

PLANS ARE SIZED 24"x36" (ARCH D).

ALL OTHER SHEETS WITHIN THIS SET OF

AROHITEOTS 2627 TILLAR STREET, SUITE 131 FORT WORTH, TX 76107 mail@schwarz-hanson.com

AXIOM MANAGEMENT & ENGINEERING, INC.

P.O. BOX 6460 FORT WORTH, TEXAS 76115 (817) 994-5420 FIRM #: F-3654

> CHRIS. A NEW FACILITY FO

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SCOTT ATWOOD, PE

DATE: 01-19-2023

**REVISION SCHEDULE** 

SHEET NAME


DRIVEWAY PERMIT PLAN

SHEET NO.

Center of driveway to be measured from

SCALE: 1" = 40'

PERMIT PLAN

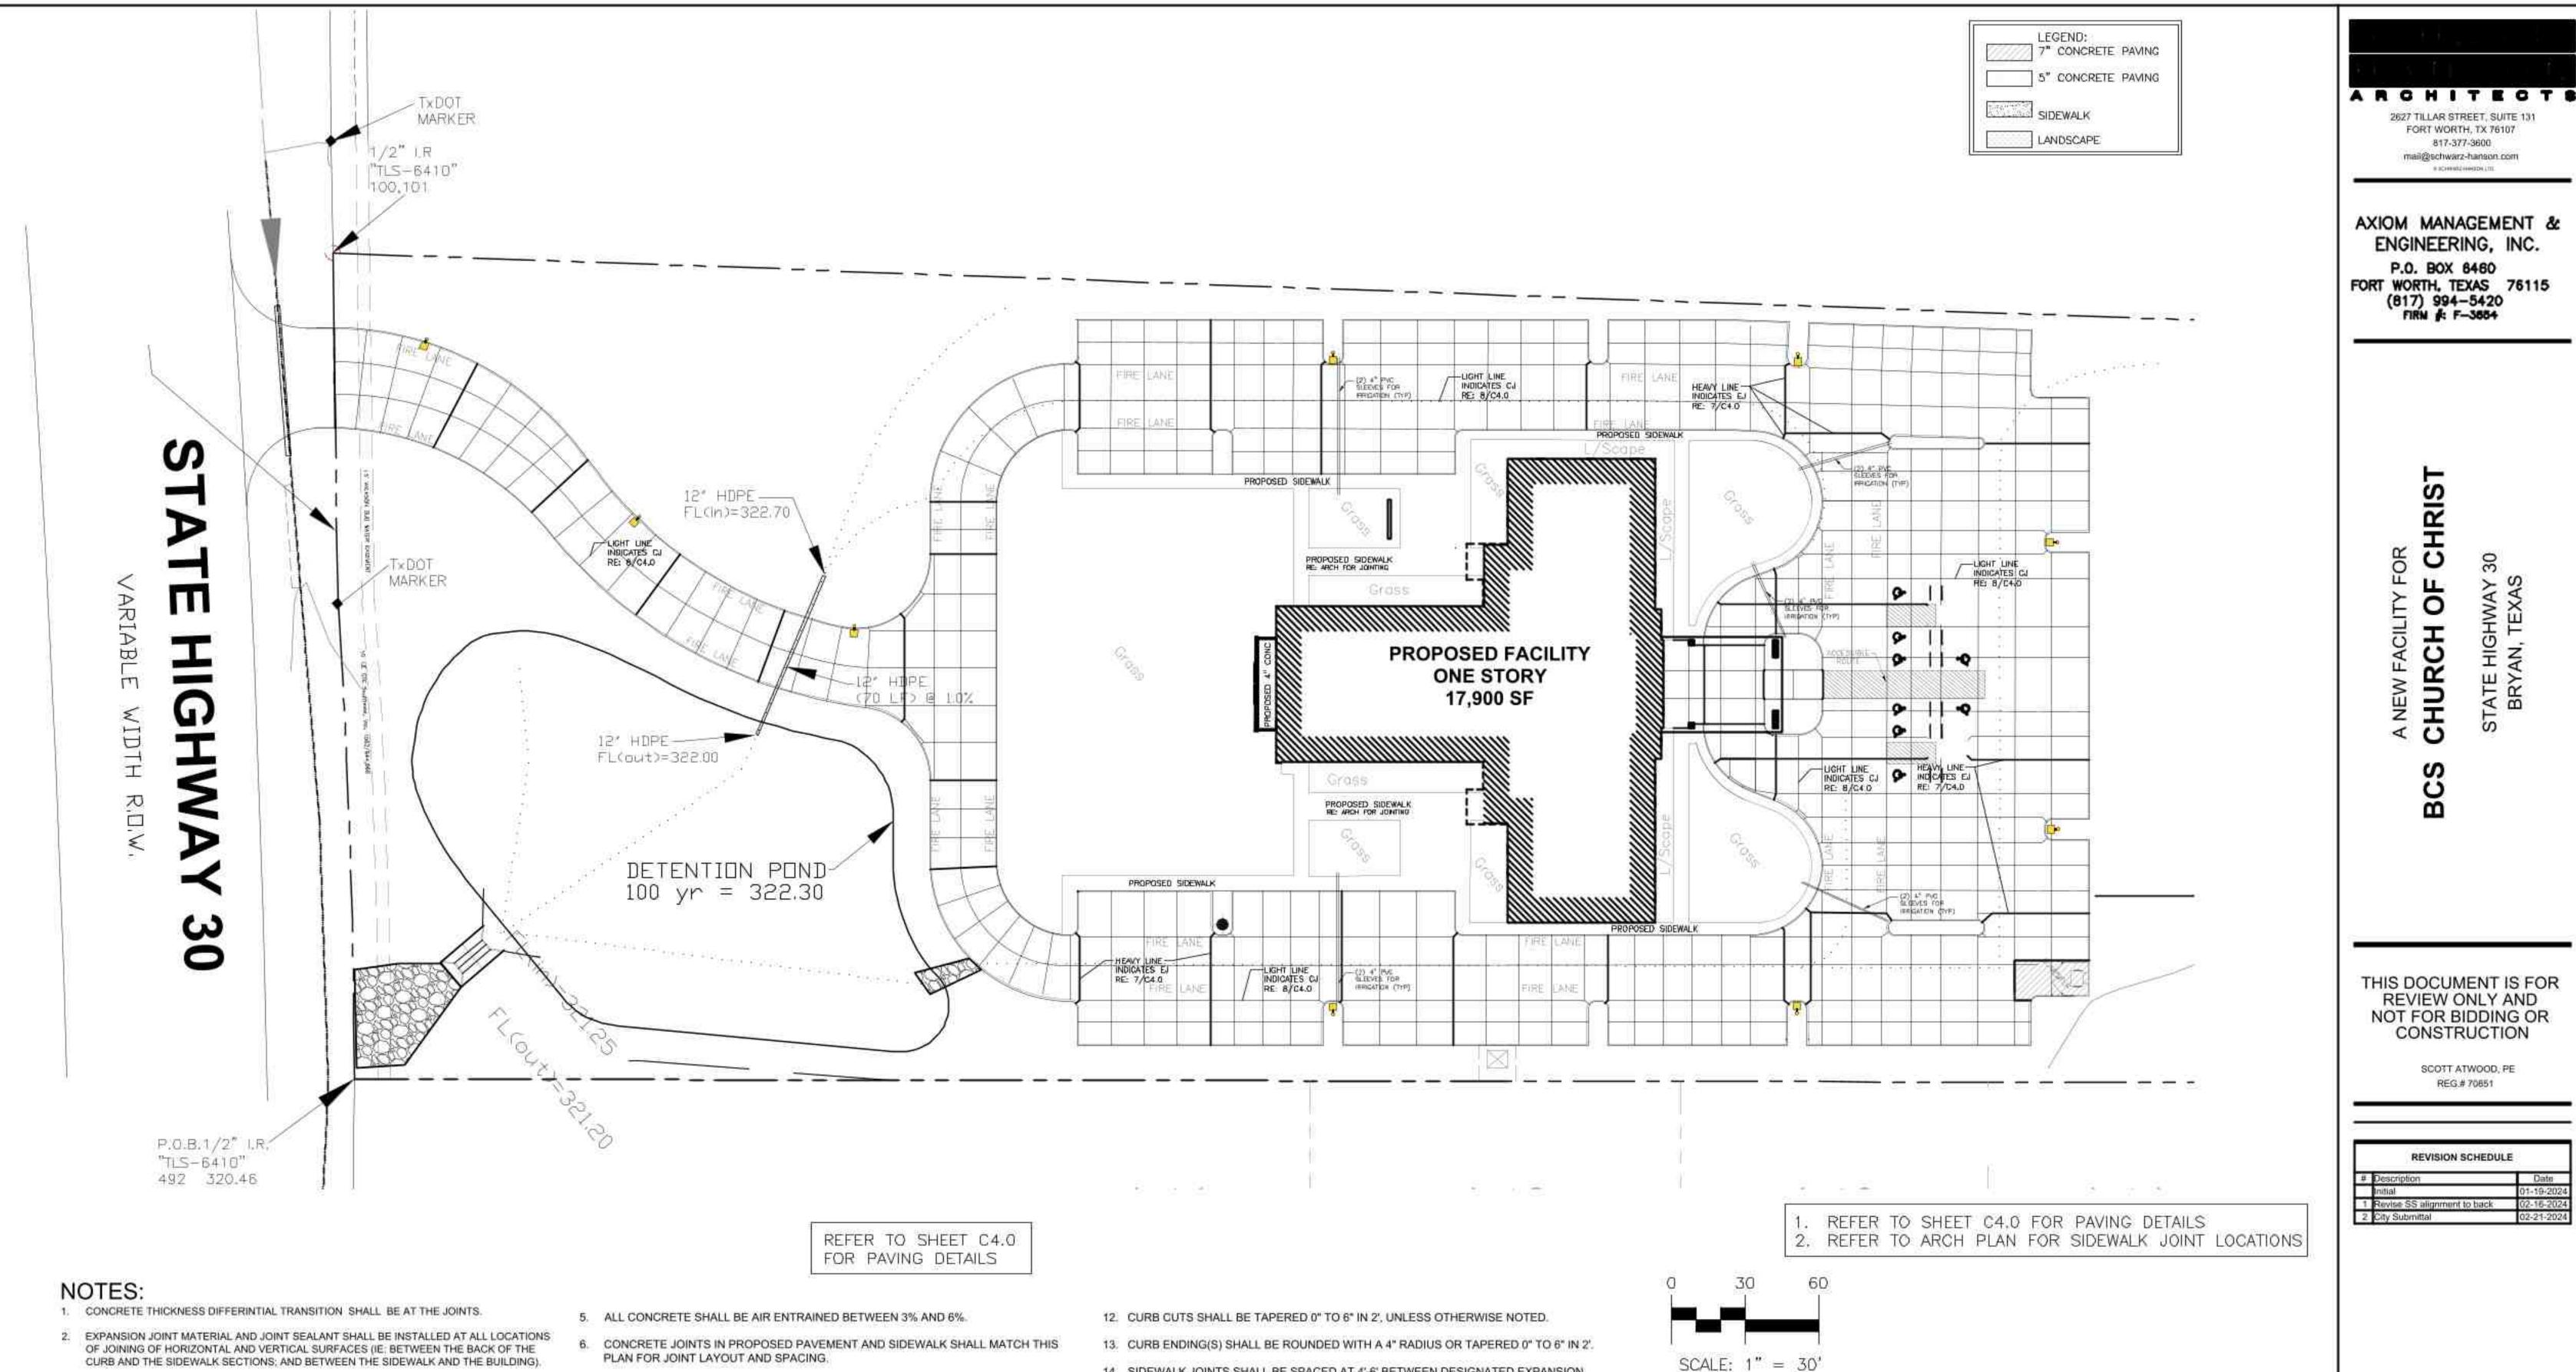

- CURB AND THE SIDEWALK SECTIONS; AND BETWEEN THE SIDEWALK AND THE BUILDING).
- CONTRACTOR SHALL PROVIDE 4" PVC SLEEVES AT ALL DRIVES & SIDEWALKS FOR IRRIGATION AND COORDINATE WITH UTILITY PLANS AND MEP PLANS PRIOR TO PAVING.
- CONCRETE SHALL MEET THE FOLLOWING:
- A) ALL ON-SITE CONCRETE WITHIN THE LIMITS OF THE PROPERTY LINES INCLUDING CONCRETE PAVING, CURB & GUTTER, SIDEWALK SHALL MEET THE PROJECT'S SPECIFICATIONS (3,500 PSI).
- B) ALL CONCRETE CURB AND GUTTER AND DRIVE APPROACHES WITHIN TXDOT'S
- RIGHT-OF-WAY SHALL MEET TXDOT'S SPECIFICATION 421 (TYPE A 3,000 PSI). C) CONCRETE FOR THE BUILDING AND OTHER MISCELLANEOUS ITEMS SHALL MEET THE PROJECT'S SPECIFICATIONS CONTAINED ELSEWHERE WITHIN THE PROJECT'S DOCUMENTS.
- PLAN FOR JOINT LAYOUT AND SPACING.
- 7. CONCRETE PAVING SAW JOINTS SHALL BE SPACED AT 9' MINIMUM TO 15' MAXIMUM BETWEEN EXPANSION JOINTS AND EQUALLY SPACED.
- 8. HANDICAP RAMPS TO MEET THE LATEST TEXAS ACCESSIBILITY STANDARDS REQUIREMENTS (2% MAXIMUM CROSS-SLOPE).
- 9. HANDICAP RAMPS SHALL HAVE PRECAST TRUNCATED DOME PANELS OR PAVERS FOR THE REQUIRED TEXTURE.
- SAWED CONTROL JOINTS SHALL BE MADE WITH POWER-DRIVEN CONCRETE SAWS. SAW JOINTS SHALL BE MADE AFTER COMPLETION OF FINISHING OPERATIONS AND AS SOON AS CONCRETE HAS HARDENED TO THE EXTENT NECESSARY FOR OPERATION OF THE SAWS WITHOUT CAUSING CHIPPING OF JOINTS OR DAMAGE TO ADJACENT CONCRETE SURFACES OR A MINIMUM OF WITHIN 24 HOURS AFTER CONCRETE IS POURED. CONCRETE LAITANCE SHALL BE WASHED FROM THE AREA IMMEDIATELY AFTER SAWING.
- 11. ALL EXPOSED SECTIONS OF THE BACK OF THE CURB SHALL BE FINISHED (HAND RUBBED).

- 14. SIDEWALK JOINTS SHALL BE SPACED AT 4'-6' BETWEEN DESIGNATED EXPANSION JOINTS AND EVENLY SPACED.
- 15. SIDEWALK CONTROL JONTS SHALL BE SAW-CUT AND NOT HAND-TOOLED WITHIN THE PRIVATE PROPERTY LIMITS. SIDEWALK CONTROL JONTS SHALL BE HAND TOOLED AND NOT SAW-CUT WITHIN THE PUBLIC (CITY AND TXDOT) ROW.
- SIDEWALK EXPANSION JOINTS SHALL BE SEALED BUT SIDEWALK CONTROL JONTS. SHALL NOT BE SEALED.
- 17. CURB FOR CONCRETE PAVEMENT SHALL BE POURED MONOLITHICALLY WITH CONCRETE PAVEMENT.

#3 - 21" #4 - 24"

COMPANIES REGARDING THE LOCATION OF EXISTING FACILITIES PRIOR TO CONSTRUCTION.

THE CONTRACTOR SHALL NOTIFY THE FOLLOWING GOVERNMENTAL AND/OR UTILITY

7" CONCRETE PAVING IN THE DUMPSTER APPROACH

5" CONCRETE PAVING IN ALL PARKING AREAS

REINFORCING STEEL LAP SPLICE LENGTHS:

6" CONCRETE PAVING IN FIRE LANES AND DRIVE APPROACHES

WICKSON CREEK SUD (WATER): CITY OF BRYAN BUILDING AND PERMIT INSPECTIONS: CITY OF BRYAN ENGINEERING:

BRAZOS ELECTRIC COOPERATIVE (ELECTRICAL SERVICE)

979-219-7814 XXX-XXX XXX-XXX XXX-XXX XXX-XXX 811

CHRIST

2627 TILLAR STREET, SUITE 131 FORT WORTH, TX 76107

> 817-377-3600 mail@schwarz-hanson.com

> > # SCHWINGHOUSE LTD.

ENGINEERING, INC.

P.O. BOX 6460

(817) 994-5420 FIRM #: F-3654

P CHURCH

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> SCOTT ATWOOD, PE REG.# 70851

REVISION SCHEDULE			
ij	Description	Date	
	Initial	01-19-2024	
1	Revise SS alignment to back	02-15-2024	
2	City Submittal	02-21-2024	

SHEET NAME


PAVING PLAN

SHEET NO.

PAVING PLAN

ALL OTHERS:

1" = 30'

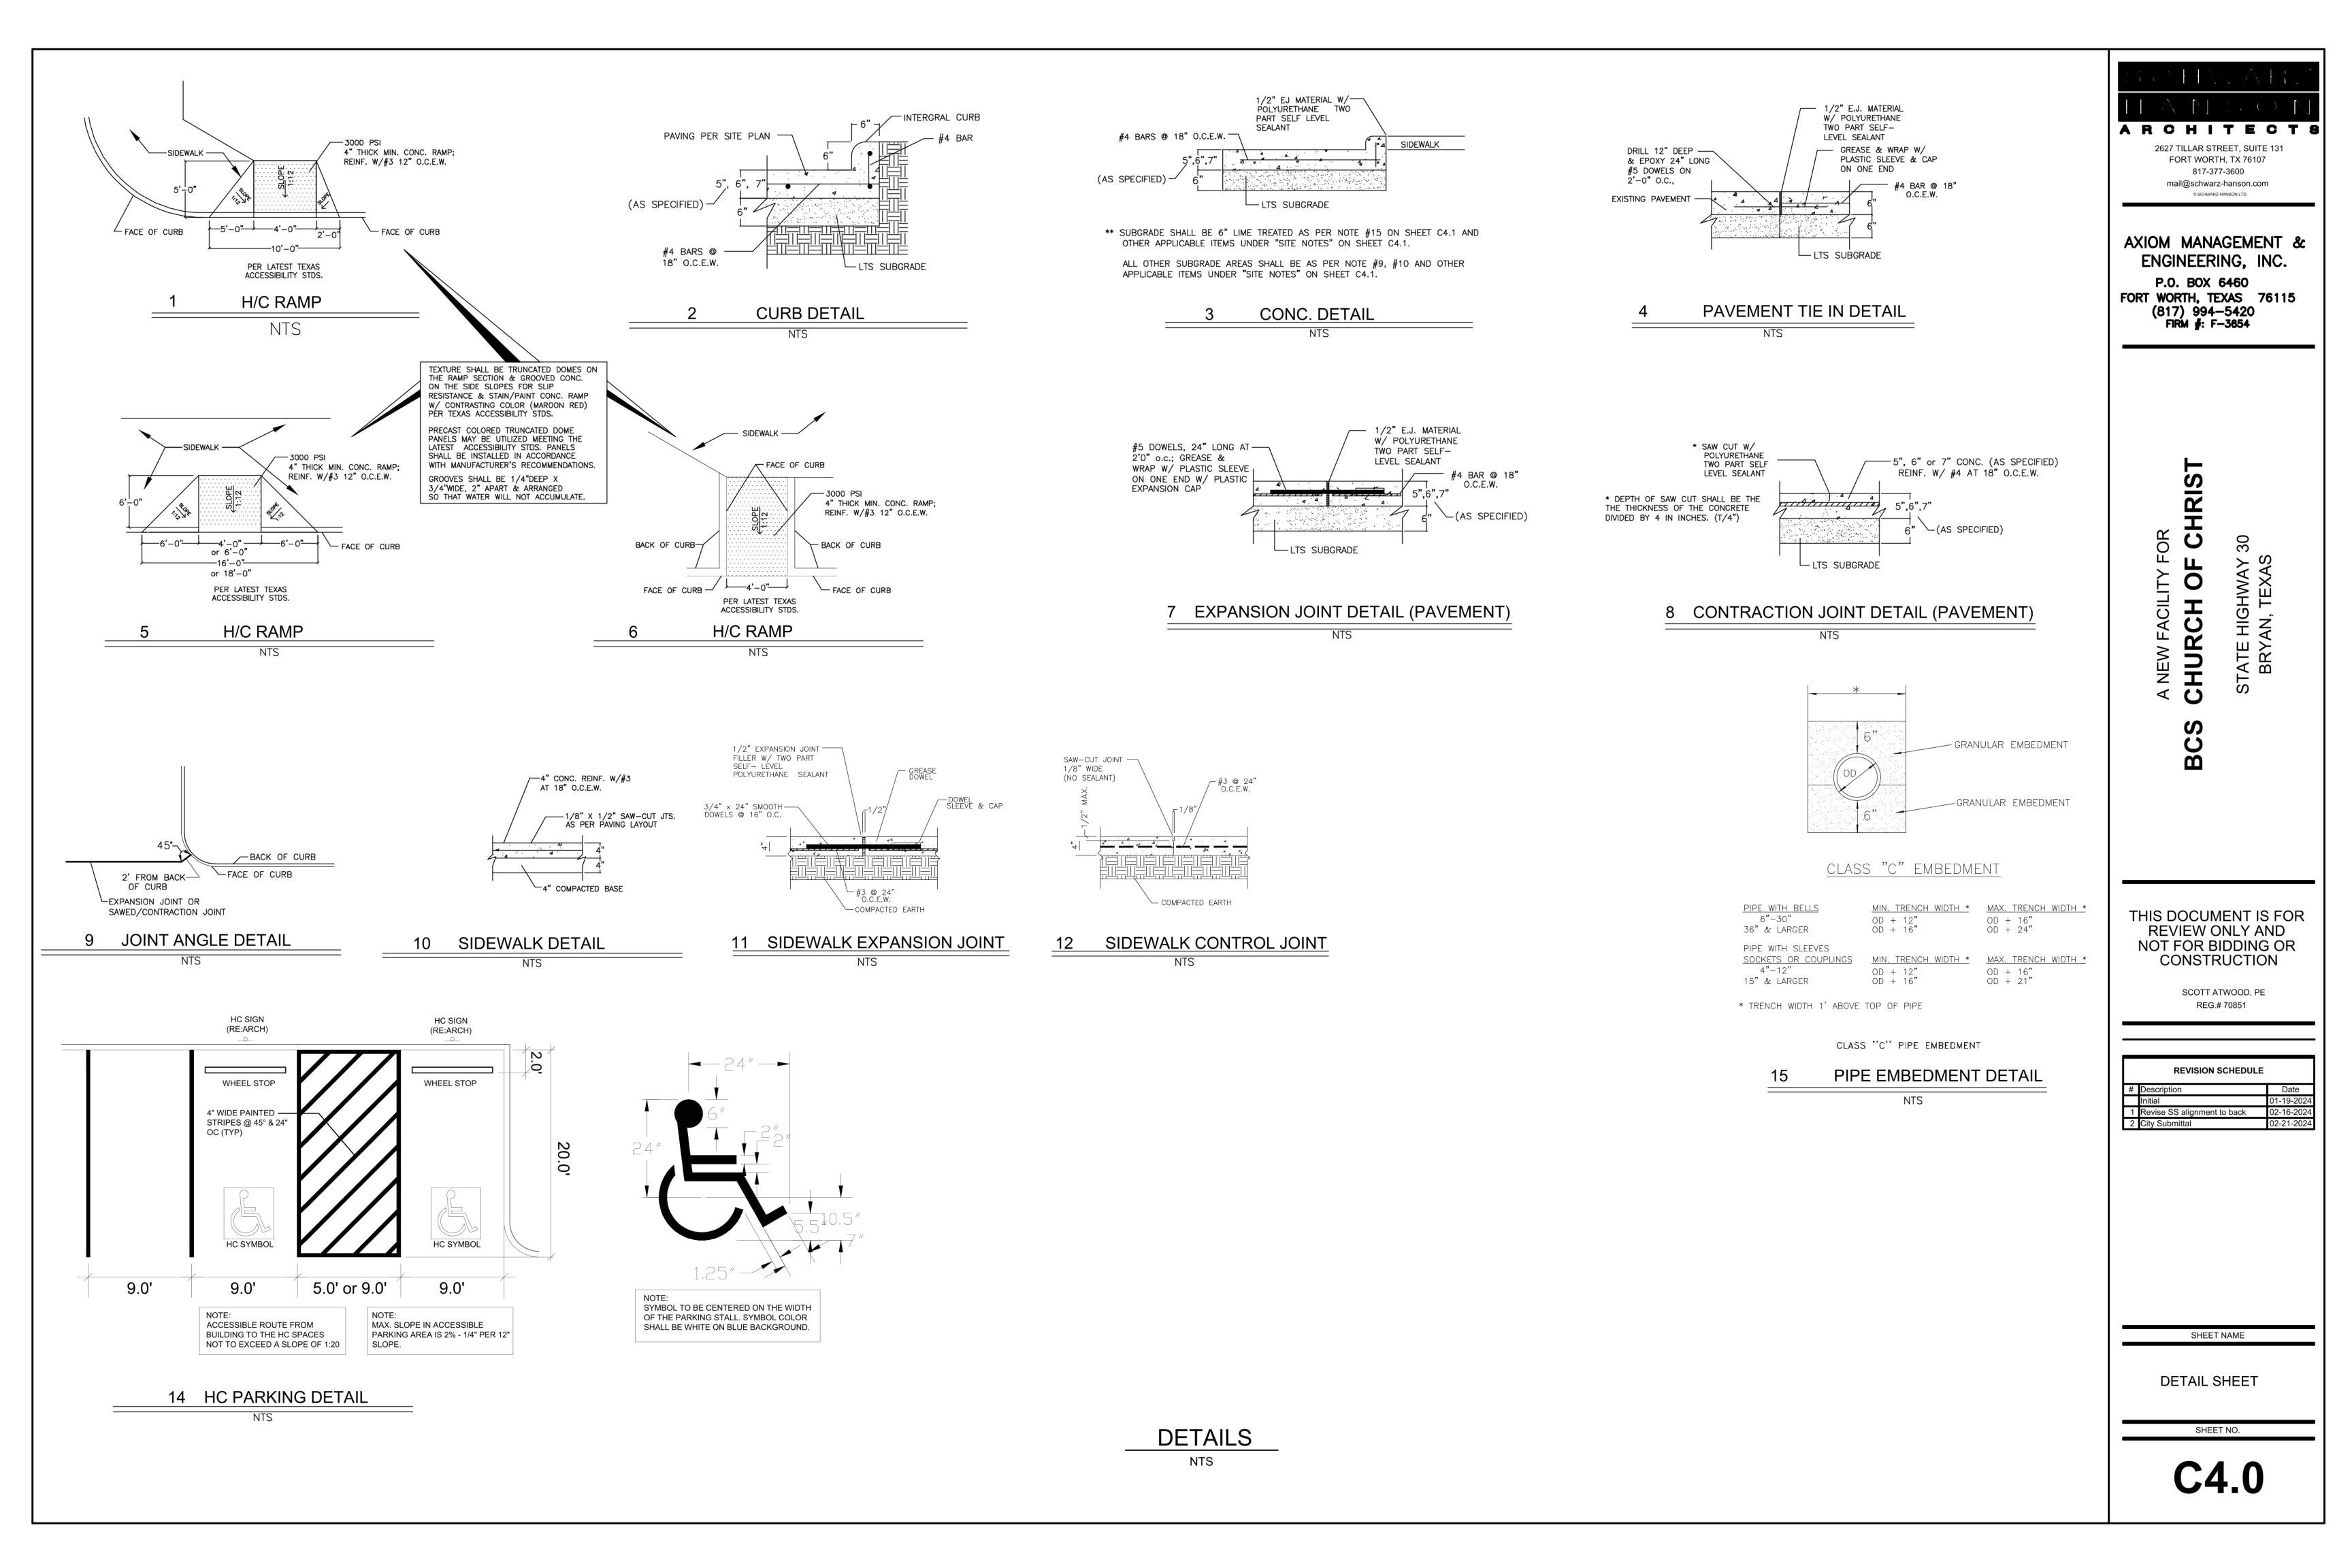

- 1. All materials and construction procedures within the scope of this project shall conform to all applicable City of Bryan Design Standards and Construction Standards and Details, City of Bryan Water Department System, City of Bryan Public Works, City of Bryan Building Code and Regulations, as well as other safety codes and inspection provisions applicable to the project and requirements of the City of Bryan Fire Department.
- 2. The Contractor shall be responsible for acquiring all permits, tests, approvals and acceptances required for completing construction of this project.
- 3. All items not specifically called for on the plans or in the specifications, but necessary to reasonably construct the facility or improvements, shall be considered incidental to the overall project and no separate payment will be made for these items.
- 4. The Contractor shall safely pothole around existing utilities, which intersect the proposed alignment of the services and notify the Engineer of potential vertical conflicts prior to any construction in the area.
- 5. The locations and depths (if provided) of existing utilities shown on these plans are approximate only. Actual locations and depths of utilities must be verified by the Contractor prior to construction. Any damage to existing utilities shall be repaired by the Contractor at his expense.
- 6. The Contractor shall notify the following governmental and/or utility companies regarding the location of existing facilities prior to construction.

  Water Wickson Creek SUD

Sewer — City of Bryan Water Department

- All others 1—800—DIG—TESS or 811

  The Contractor shall maintain all irrigation zones once installed throughout the remaining time of the project.
- 8. Contractor shall provide traffic control devices in conformance with the Texas Manual on Uniform Traffic Control Devices.
- 9. Contractor shall develop, submit for approval, implement and maintain a Traffic Control Plan signed and sealed by a licenced engineer in the State of Texas for all lane closures including both temporary (daytime and overnight) and long term in accordance with the City and TxDOT requirements.
- 10. City noise ordinance shall be adhered to at all times. Contractor shall familiarize himself with the appropriate ordinances.

Site Notes:

- 1. The Contractor shall familiarize themselves with the Report of Geotechnical Study by Dudley Engineering, LLC dated November 14, 2023.
- 2. Contractor shall provide erosion control onsite in conformance with all jurisdictions including City of Bryan.
- 3. Drainage shall be unimpeded during the course of the construction.
- 4. The Detention Pond is to be excavated prior to paving and the pouring of the foundation.
- 5. Erosion control devices shall be installed prior to any soil disturbance in areas where surface water would run off this site.
- 6. Inlet protection shall be installed around the inlets (if on or adjacent to the site) so to prevent sediment from entering the drainage system.
- 7. After completion of development, silt fences shall be installed at areas of erosion and at locations where pollutants could enter the drainage system. Parkways, and other areas of concentrated flow shall be sodded or hydromulched with Bermuda and other grasses as necessary to prevent sediment from washing into the system.
- 8. All concrete for civil appurtenances shall be 3,500 psi compressive strength @ 28 days.
- 9. On—site topsoil may be utilized. The Contractor may import topsoil as required by the Landscape plans and specifications.
- 10. Subgrade shall be scarified and re-compacted over 6" in depth in areas, which receive fills. Compact to between 95% and 100% Standard Proctor at maximum dry density as per ASTM D698 (Standard Proctor) with a -2% to +2% of optimum moisture content.
- 11. On—site soil may be utilized in areas outside the footprint of the building(s). Compact to between 95% and 100% Standard Proctor at maximum dry density at ASTM D698 (Standard Proctor) with a 0% to +4% of optimum moisture content.
- 12. Imported soil (non-select fill) may be utilized in areas outside the footprint of the building(s). Imported soil shall have a maximum plasticity index (PI) of 20. Compact to between a 95% and 100% of standard proctor maximum dry density according to ASTM D698 (Standard Proctor) with a +/-2% to +4% of optimum moisture
- 13. Imported select fill material to be either material meeting (LL<35; 4<Pl<16) or crushed limestone base material meeting the requirements of the Texas Department of Transportation (TxDOT) 2004 Standard Specifications Item 247, Type A, Grade 2 having a Plasticity Index less than or equal to 12 and a Liquid Limit less than or equal to 40. Compact to between a 95% and 100% of standard proctor maximum dry density according to ASTM D698 (Standard Proctor) with a 2% to +2% of optimum moisture content.
- 14. Fill material shall be placed in loose lifts not exceeding 8 inches in un—compacted thickness. Clods and chunks of material should be broken and fill material mixed by disking, blading, or plowing, as necessary, so that a material of uniform moisture and density is obtained for each lift.
- 15. The paving subgrade shall be lime treated stabilization with 7.5% lime or the Contractor can choose to run a lime series test to determine the required amount of lime required. Compact the lime treated subgrade to between 96% and 100% of standard proctor maximum dry density according to ASTM D698 (Standard Proctor) with a +/- 0% to +4% of optimum moisture content.
- 16. Prior to lime treating the subgrade, the Contractor shall have soluble—sulfate tests ran to verify the soil can safely be treated with lime. The frequency shall be 1 test per every 5,000 sf of pavement area. Refer to the Geotechnical Study for further details and information. The Engineer shall be notified if results are greater than 3,000 parts per million.
- 17. Contractor shall be responsible for all quality control testing including soil Proctors and densities and concrete compressive strengths.
- 18. Density Testing Frequency: One test per lift per 2,000 sf in the building pad; one test per lift per 5,000 sf in the non-building pad areas; one test per lift per 150 LF of utility backfill. A minimum of three density verification tests per lift shall be performed.
- 17. Prior to placement of concrete for concrete pavement, the Contractor shall proof—roll with a loaded dump truck or water truck the areas receiving concrete. Soft areas shall be removed and reworked prior to placement of concrete.
- 19. Excavated material may be utilized on site and excess material shall be disposed off—site at an Owner and City approved location.
- 20. Contractor shall verify all grades onsite and shall notify the Engineer of any
- 21. Contractor shall paint all pavement markings within the Private property limits.
- 22. Parking lane lines shall be painted Traffic White and shall be 4" wide.
- 23. Firelane to be 6" painted red stripe with 4" white letters stating "FIRE LANE NO PARKING" every 10 to 25 feet along the entire length of the fire lane.
- 24. "FIRE LANE NO PARKING" markings shall be on the vertical face of the curb when a curb is present.
- 25. Trees not noted to be removed shall be protected against damage.
- 26. Trees damaged as a result of the Contractor's negligence shall be replaced in kind at the Contractor's expense.
- 27. All islands to be grassed or landscaped as per Landscape Plans.
- 28. All trees, stumps, brush, abandoned structures, roots, vegetation, rubbish & any other undesirable material shall be removed and disposed of properly.

**Utility Notes:** 

- 1. All utility connections to the building shall be coordinated with the mechanical and electrical plans. For information on gas, electric, and telephone utilities, see the mechanical and electrical plans.
- 2. Trench Excavation Protection Contractor and /or Contractor's independently retained employee, or structural design/Geotechnical/safety/ equipment consultant if any, shall review these plans and available Geotechnical information and the anticipated installation site(s) within the project work area in order to implement the Contractor's trench excavation safety protection systems, programs and /or procedures for the project described in the contract documents. The Contractor's implementation of these systems, programs and /or procedures shall provide for adequate trench excavation safety protection that complies with, as a minimum OSHA standards for trench excavations. Specifically, Contractor and/or Contractor's independently retained employee, or safety consultant shall implement a trench safety program in accordance with OSHA standards governing the presence and activities of individuals working in and around for trench excavations.
- 3. Domestic water, irrigation, and sanitary sewer service shall be installed and tested in accordance with Wickson Creek SUD and/or the City of Bryan Water System Department and Public Works Department and Standard Construction Details. The Contractor shall coordinate with the appropriate Agency/Department for permitting, inspections, and construction operations.
- 4. Depth of bury of all piping shall be a minimum of 24", unless otherwise noted.
- 5. The water service shall be located at the property line, no more than 24" deep and covered with a meter box in place at grade.
- 6. Tap size to be as shown on the plans.
- 7. Service line shall be Type "K" as specified in ASTM B88.
- 3. All water mains, including fire lines, to be PVC AWWA C-900, Class 150, DR-18.
- . All water mains, including fire lies, shall have 42 inch minimum cover from finished grade.
- 10. All iron fittings including fire hydrants and valves shall be poly wrapped.
- 11. Stainless steel tapping saddles shall be used for services.
- 12. Water service shall include furnishing and installing heavy duty meter box as approved by the appropriate Agency/Department.

  13. Fire hydrant painting and installation shall conform to the City of Bryan Fire
- 13. Fire hydrant painting and installation shall conform to the City of Bryan Fire Hydrant Standard Detail. Fire hydrants shall be installed a minimum of 2' from the back of the curb.
- 14. Concrete thrust blocking shall be placed on all water line bends and shall be in accordance with the appropriate Agency/Department Standard Construction Details.
- 15. All proposed gravity sanitary sewer systems' lateral pipe and fittings shall be SDR 35 PVC pipe and shall be as shown in the City of Bryan Construction Standard Details
- 16. All sanitary sewer pipe and cleanouts used for lateral services shall be green in color.
- 17. All sanitary sewer laterals shall be installed in accordance with the sanitary sewer embedment and backfill standards.
- 18. All cleanouts are to be constructed of PVC pipe type SDR-35.
- 19. PVC sewer pipe and fittings shall conform to the current ASTM Designation D3034 for four (4) inches through fifteen (15) inches.
- 20. The Contractor shall verify the location and elevation of existing sanitary sewer lines and manholes prior to construction
- lines and manholes prior to construction.

  21. No water jetting is allowed on this project.
- 22. Contractor shall compact all utility trenches to 95% standard proctor with 2% to +4% of optimum moisture content.
- 23. Contractor shall coordinate work, which affects the adjacent property owners.
- 24. Contractor shall remove and replace all utilities, landscaping, irrigation, signage,
- etc. on property & adjacent property with which this project affects.

  25. Contractor shall be responsible for all damages occurred to adjacent property and shall replace at the Contractor's sole expense all damaged appurtenances, which are a result of the Contractor's negligence during the performance of this
- 26. Contractor shall replace all damaged grassed areas on adjacent property with block sod of like kind in which the Contractor's work affects.
- 27. Contractor shall coordinate electric, gas, and telephone service directly with the local utility companies.
- 28. The communication system conduit shall not have any 90 degree abrupt bends. Bends shall consist of sweeps from 2' to 3' radius bends.

ARCHITECTS

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> SCOTT ATWOOD, PE REG.# 70851


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Initial 01-19-2024
1 Revise SS alignment to back 02-16-2024
2 City Submittal 02-21-2024


SHEET NAME

**GENERAL NOTES** 

SHEET NO.

C4.1

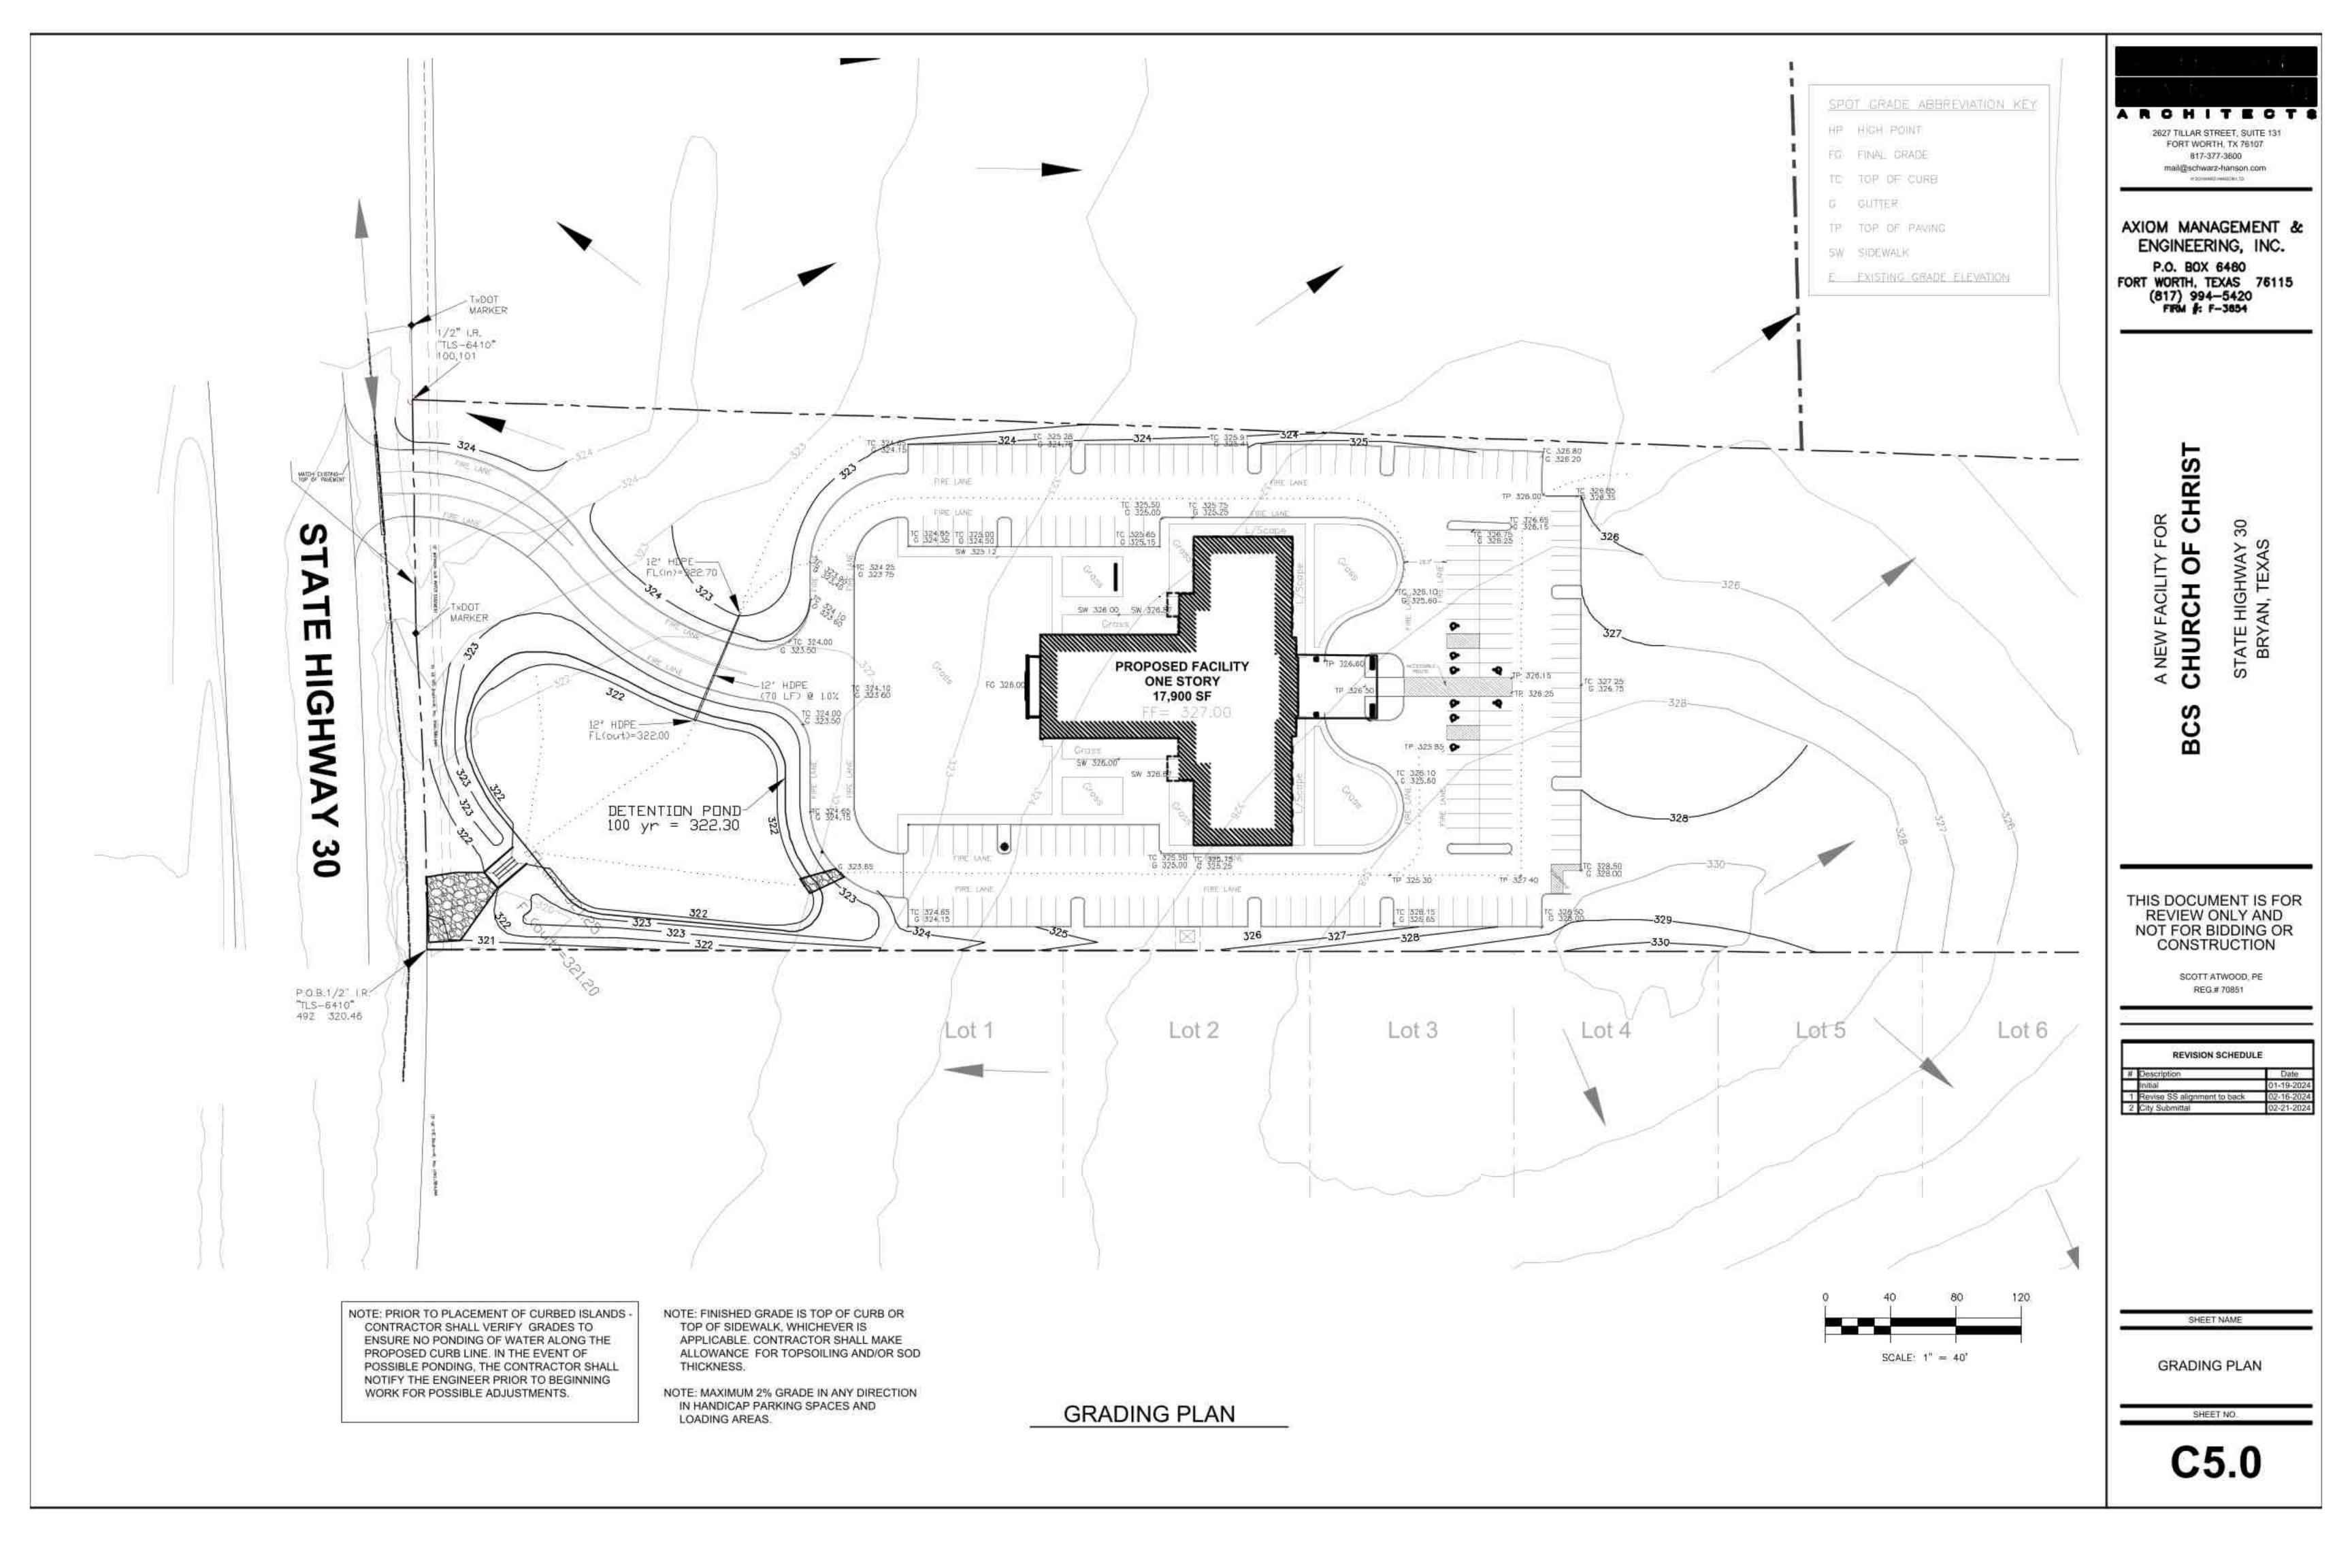

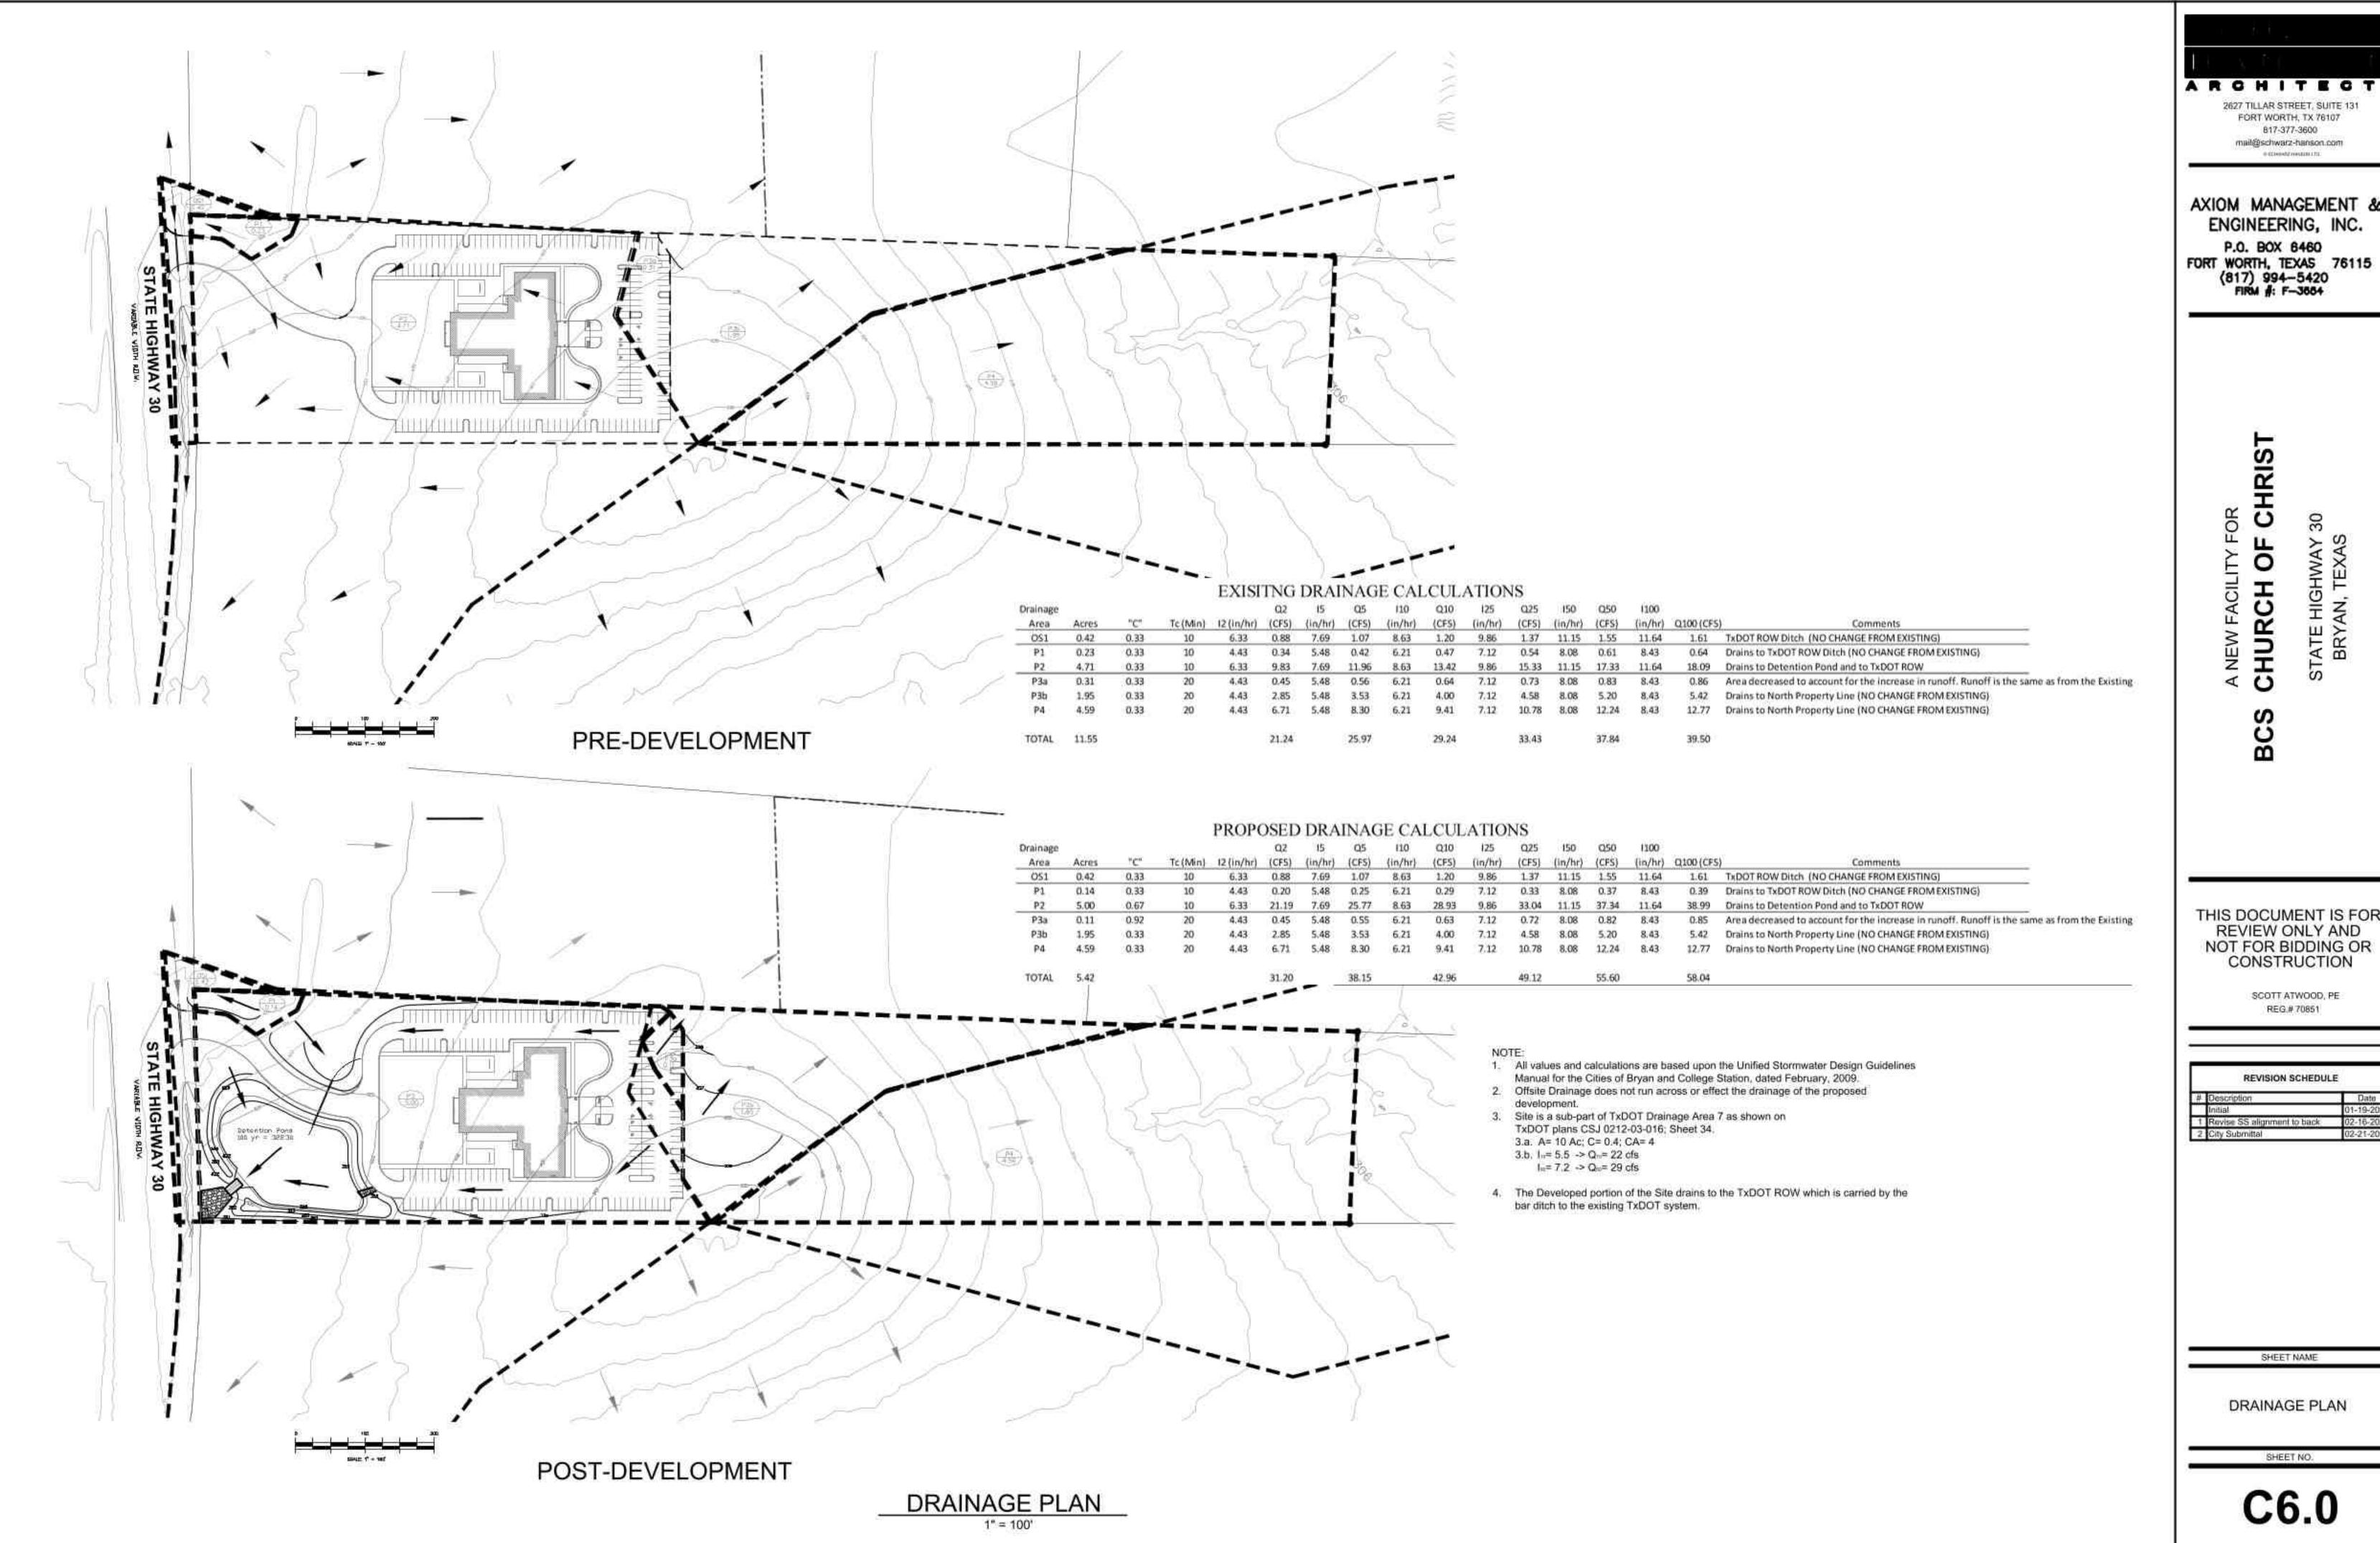

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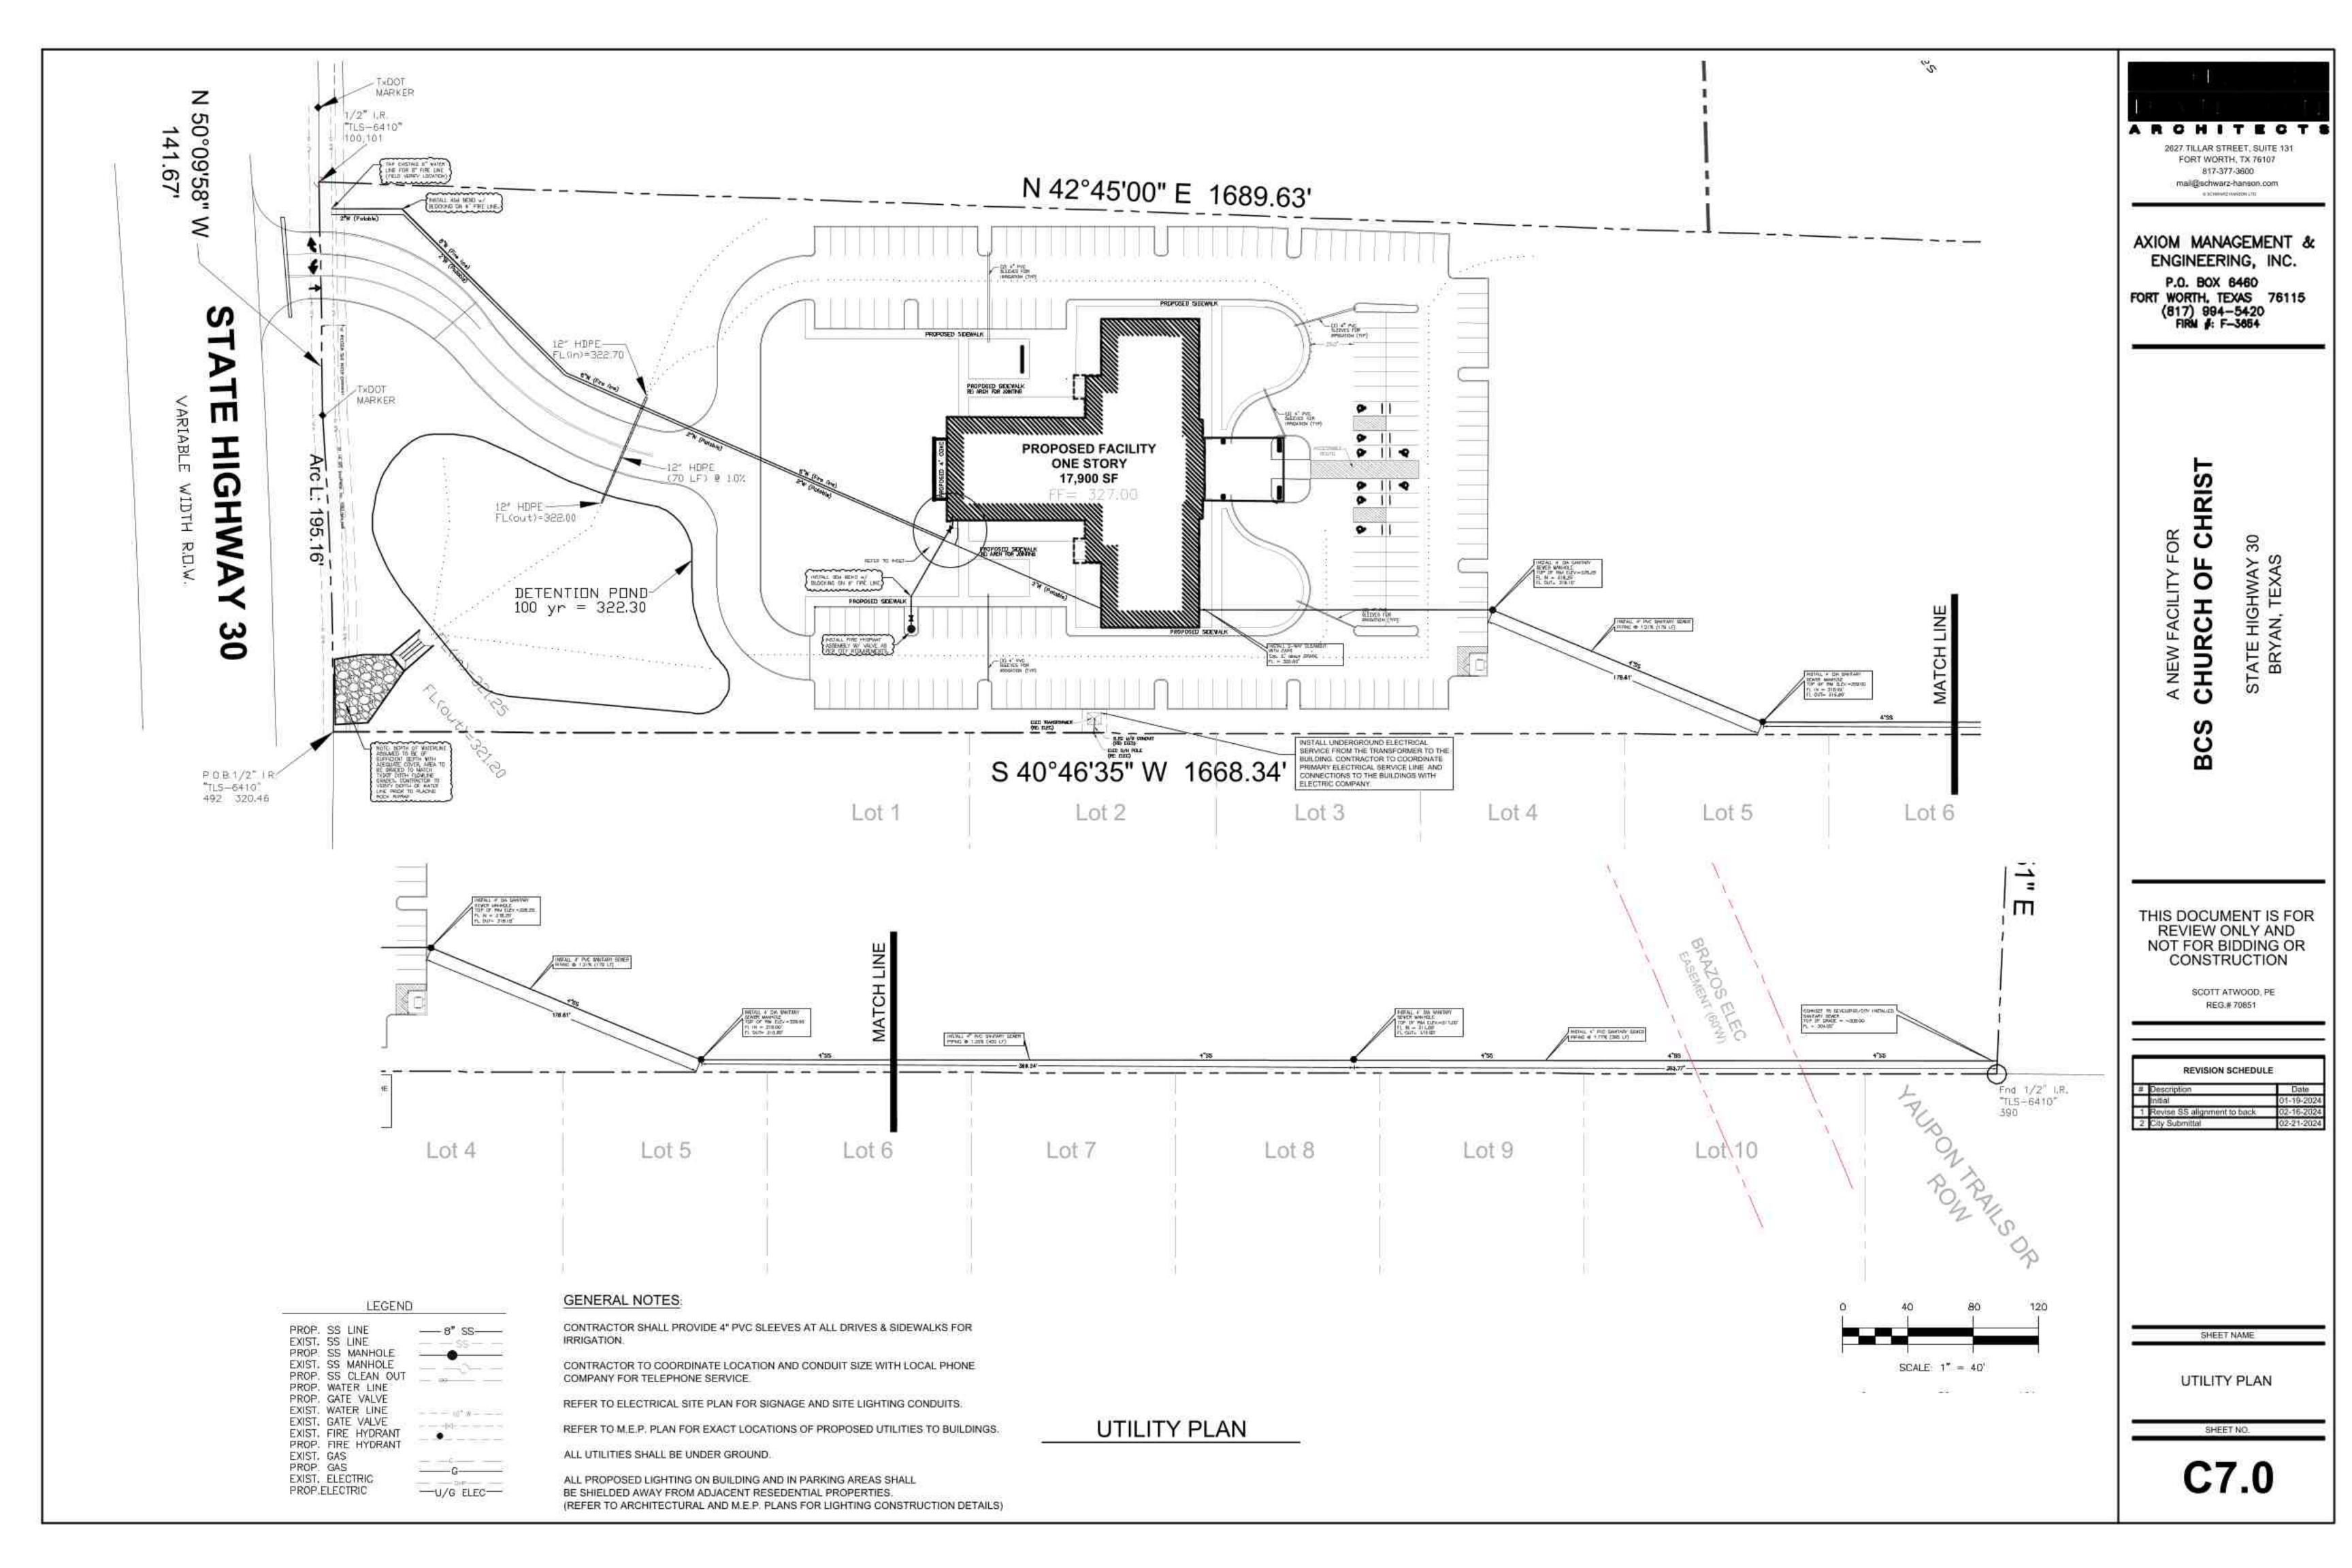
REVISION SCHEDULE			
Description	Date		
Initial	01-19-2024		
Revise SS alignment to back	02-16-2024		
City Submittal	02-21-2024		


SHEET NAME

DRAINAGE PLAN

SHEET NO.

C6.0



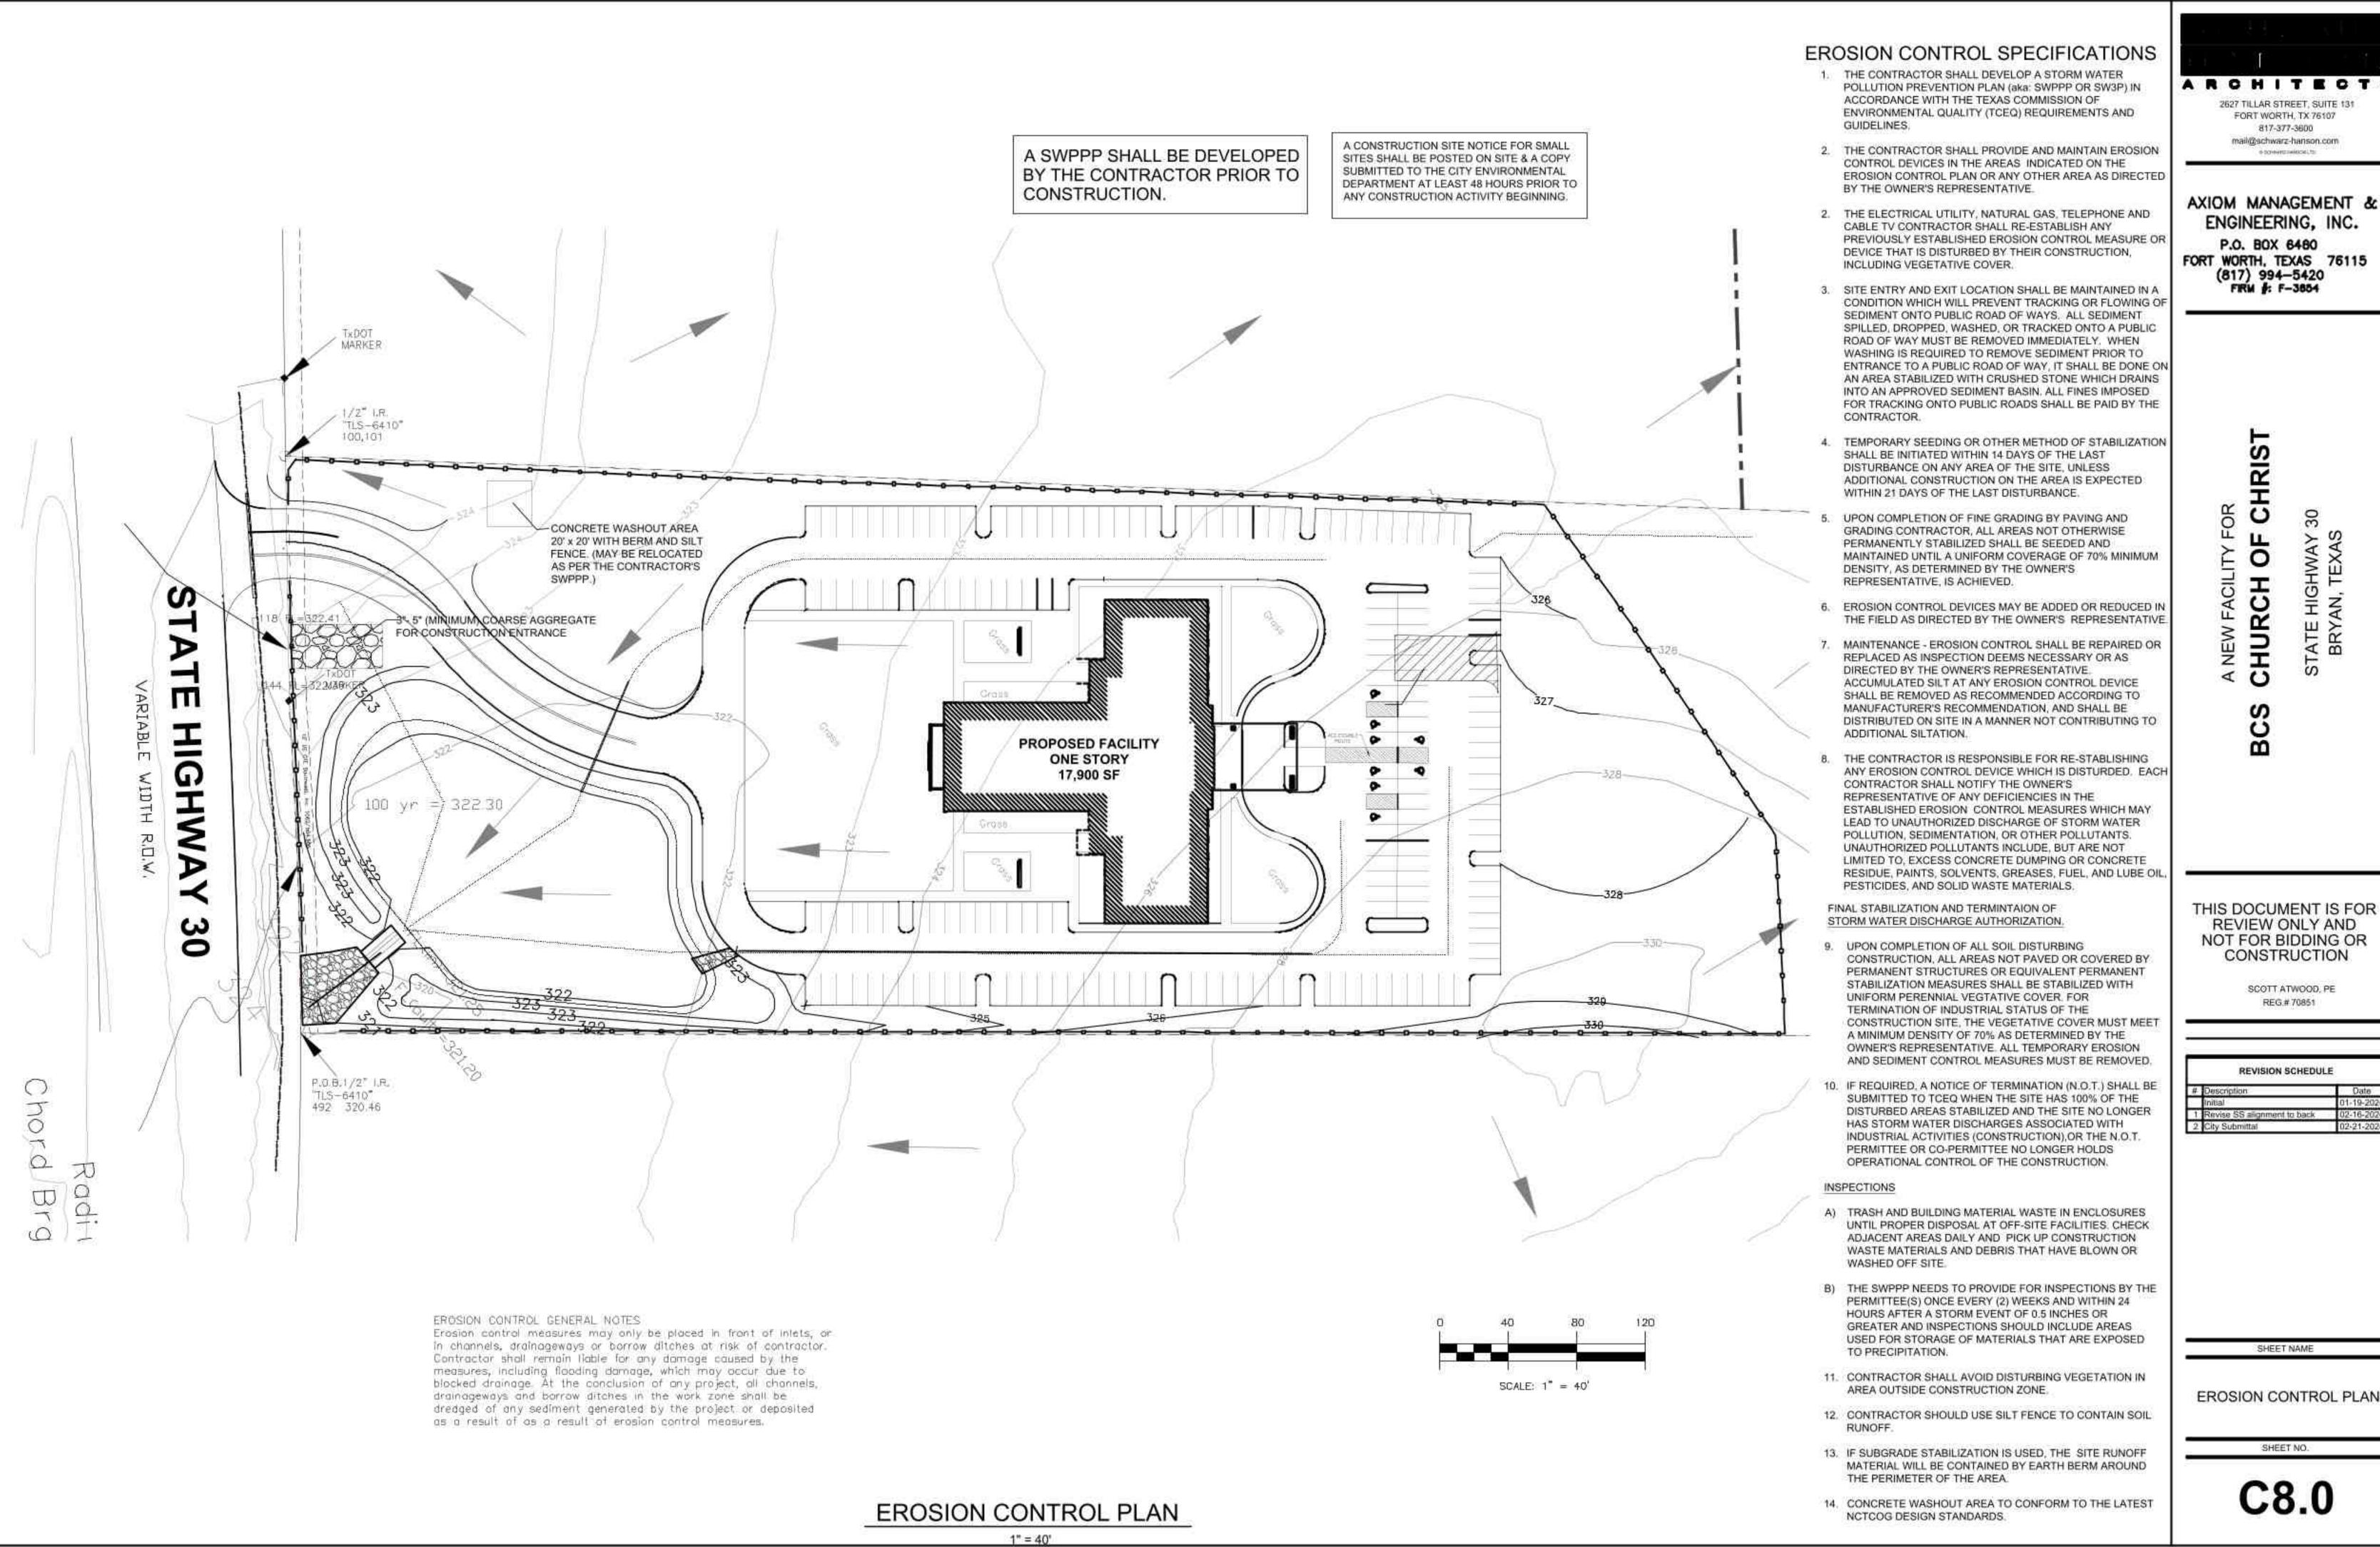

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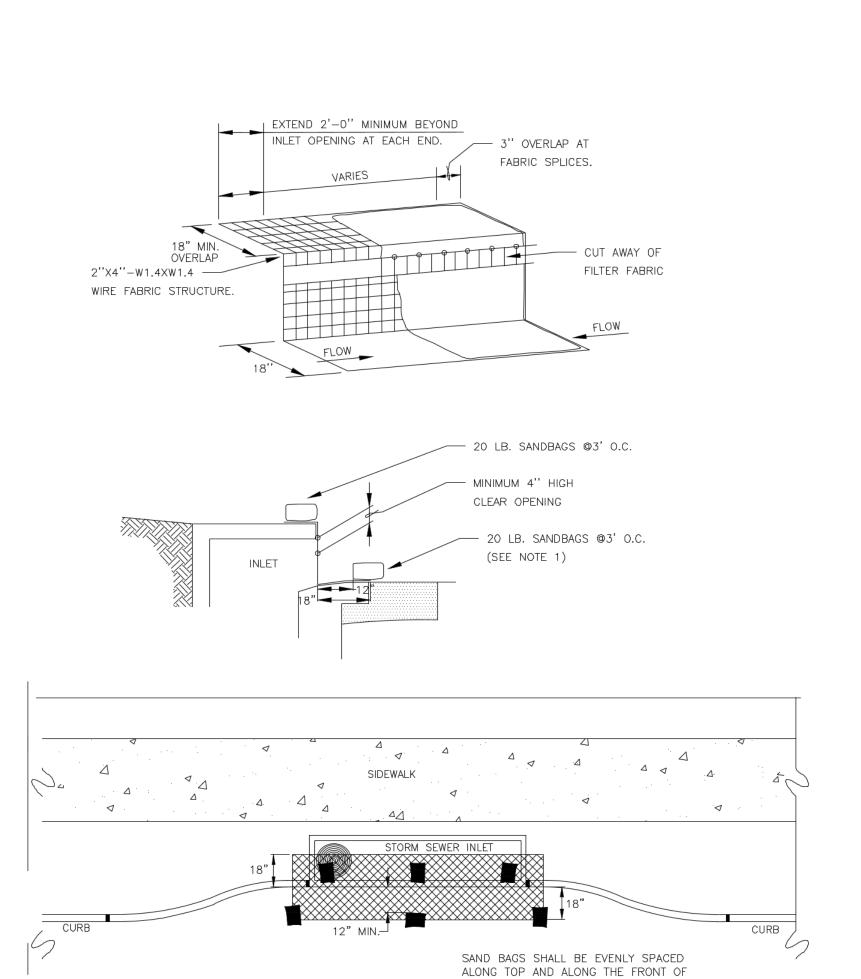
> SCOTT ATWOOD, PE REG.# 70851

REVISION SCHEDULE

SHEET NAME


**EROSION CONTROL PLAN** 

SHEET NO.




### CURB INLET PROTECTION DETAIL


- 1. A SECTION OF FILTER FABRIC SHALL BE REMOVED AS SHOWN ON THIS DETAIL TO PROVIDE A 4" MINIMUM CLEAR OPENING. FABRIC MUST BE SECURED TO WIRE BACKING WITH CLIPS OR HOG RINGS AT THIS LOCATION.
- 2. INSPECTION SHALL BE MADE BY THE CONTRACTOR AND SILT ACCUMULATION MUST BE REMOVED WHEN DEPTH
- 3. CONTRACTOR SHALL MONITOR THE PERFORMANCE OF INLET PROTECTION DURING EACH RAINFALL EVENT AND IMMEDIATELY REMOVE THE INLET PROTECTIONS IF THE STORM-WATER BEGINS TO OVERTOP THE CURB.
- 4. INLET PROTECTIONS SHALL BE REMOVED AS SOON AS THE SOURCE OF SEDIMENT IS STABILIZED.

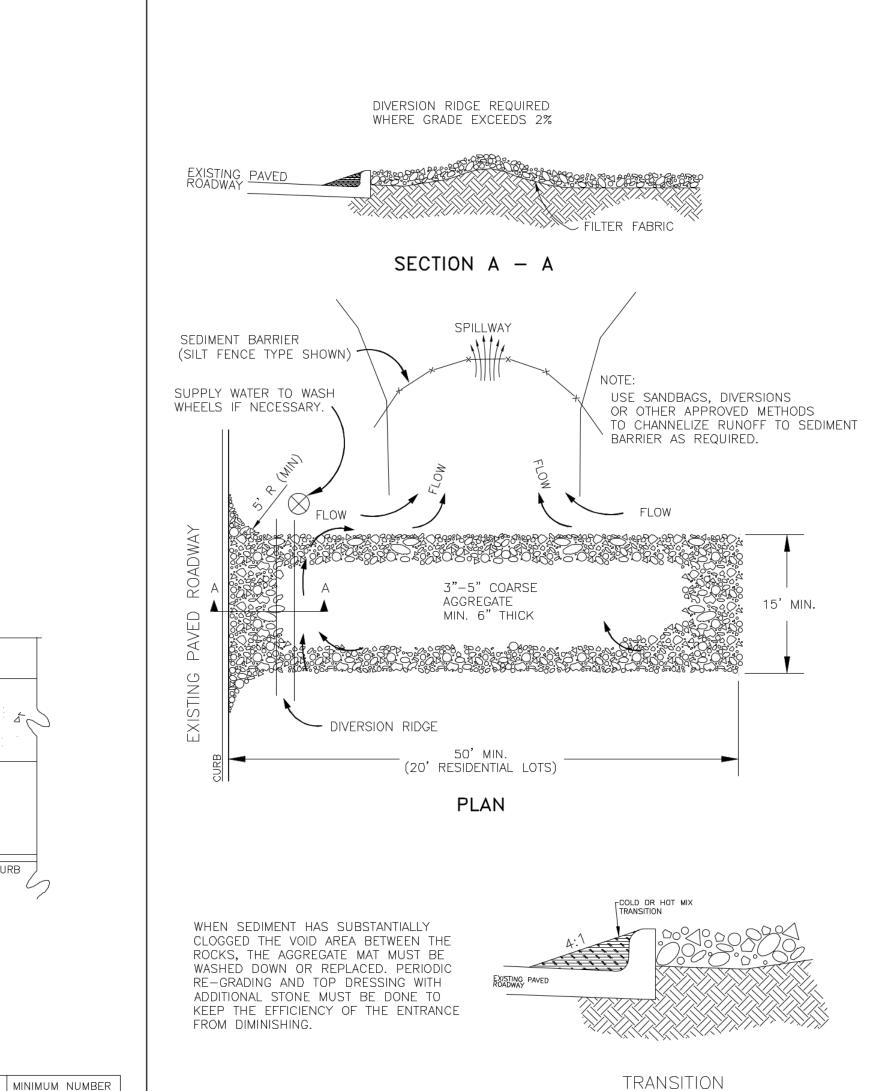



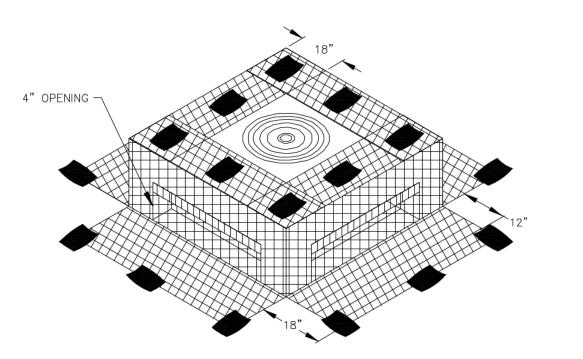

ISOMETRIC VIEW

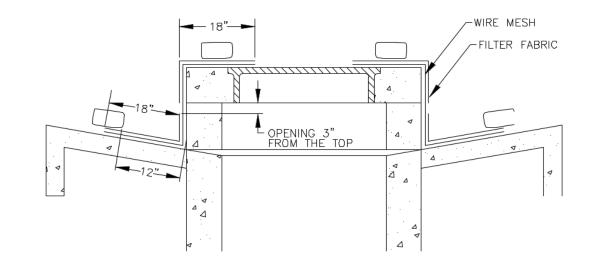

SECTION

FILTER FABRIC WYE INLET PROTECTION N.T.S.

#### ESTABLISHMENT OF GROUND COVER

1. Eighty percent (80%) evenly distributed ground cover, without large bare areas, shall be established after the designated areas have been completed to the lines, grades and cross sections shown on the plans and prior to final acceptance by the City Engineer.

2. Ground cover shall be established as per North Central Texas Council of Governments (N.C.T.C.O.G.) "STANDARD SPECIFICATIONS FOR PUBLIC WORKS CONSTRUCTION" 202.6 Seeding Turfgrass. Copies may be obtained from the "NORTH CENTRAL COUNCIL OF GOVERNMENTS", PO Drawer 5888, Arlington, Texas, 76005-5888, Phone (817) 640-3300, also available at www.publicworks.dfwinfo.com. A copy of the contract documents, plans and specifications shall be available on—site at all times by the Contractor.

3. Prior to planting, contractor shall provide the City Engineer, or his designee, with the State of Texas Certificate stating analysis of purity and germination of

4. Planting season and application rates. All planting shall be done between the dates specified in Table 1, for each grass type except when specifically authorized in writing. The seeds planted per acre shall be of a type specified with the mixture, rate and planting dates as shown in the Table 1, or as specified by the Engineer.

#### Table 1. Seeding Turfgrass

TYPE	PLANTING SEASON	SEED AND RATE
TYPE I	MARCH THROUGH SEPTEMBER	BERMUDA GRASS, HULLED 50-LB (22.7-KG) PLS <sup>1</sup> PER ACRE
TYPE II	OCTOBER THROUGH FEBRUARY	RYE GRASS, 100-LB (45.4-KG) PLS PER ACRE COMBINED WITH BERMUDA GRASS, HULLED 20-LB (9.1-KG) PLS <sup>1</sup> PER ACRE.
OTHER	AS SPECIFIED ON PLANS	AS SPECIFIED ON PLANS

<sup>1</sup>PLS — Pure Live Seed is determined by multiplying the gross weight times purity times the germination [For example, a 100—1b bag with 85% purity and 80% germination. (PLS=pounds in bag x Purity x germination) 100 x 0.85 x 0.8 = 60.8 —1bs of pure live

5. Seeded areas shall be maintained, including watering and mowing, at such time and in a manner and quality to establish a minimum 80% evenly distributed ground cover, without large bare areas, until completion and final acceptance of the project by the City Engineer.

# COMPACTED EARTH — OR ROCK BACKFILL


✓ FABRIC TOE−IN

OPENING OF SAND BAGS
TOP FRONT

10' 3 3

5' 2

20' 4

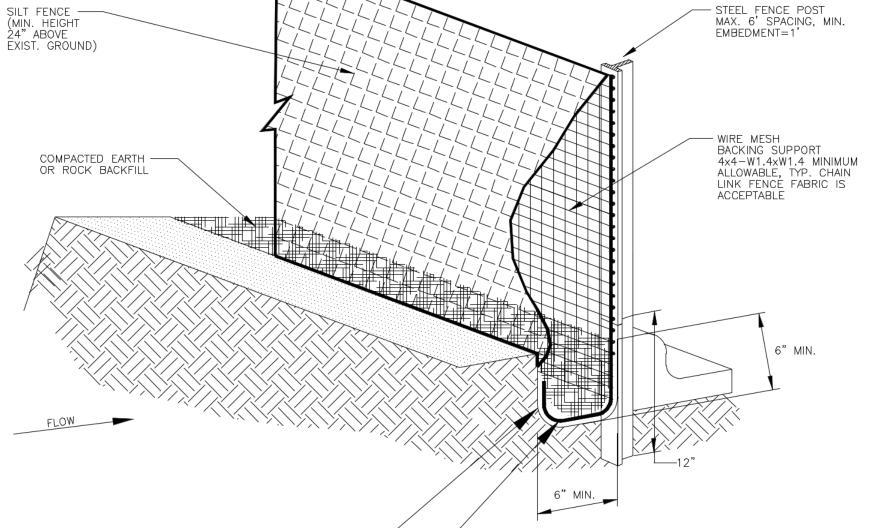

ISOMETRIC PLAN VIEW

#### SILT FENCE GENERAL NOTES

1. STEEL POSTS WHICH SUPPORT THE SILT FENCE SHALL BE INSTALLED ON A SLIGHT ANGLE TOWARD THE ANTICIPATED RUNOFF SOURCE. POST MUST BE EMBEDDED A MINIMUM OF ONE FOOT.

2. THE TOE OF THE SILT FENCE SHALL BE TRENCHED IN WITH A SPADE OR MECHANICAL TRENCHER, SO THAT THE DOWNSLOPE FACE OF THE TRENCH IS FLAT AND PERPENDICULAR TO THE LINE OF FLOW. WHERE FENCE CANNOT BE TRENCHED IN (e.g. PAVEMENT), WEIGHT FABRIC FLAP WITH ROCK ON UPHILL SIDE TO PREVENT FLOW FROM SEEPING UNDER FENCE.

3. THE TRENCH MUST BE A MINIMUM OF 6 INCHES DEEP AND 6 INCHES WIDE TO ALLOW FOR THE SILT FENCE FABRIC TO BE LAID IN THE GROUND AND BACKFILLED WITH COMPACTED MATERIAL.

4. SILT FENCE SHOULD BE SECURELY FASTENED TO EACH STEEL SUPPORT POST OR TO WOVEN WIRE, WHICH IN TURN IS ATTACHED TO THE STEEL FENCE POST. THERE SHALL BE A 3 FOOT OVERLAP, SECURELY FASTENED WHERE ENDS OF FABRIC MEET.

5. INSPECTION SHALL BE MADE EVERY TWO WEEKS AND AFTER EACH 1/2" RAINFALL. REPAIR OR REPLACEMENT SHALL BE MADE PROMPTLY AS NEÉDED.

6. SILT FENCE SHALL BE REMOVED WHEN THE SITE IS COMPLETELY STABILIZED SO AS NOT TO BLOCK OR IMPEDE STORM FLOW OR DRAINAGE.

7. ACCUMULATED SILT SHALL BE REMOVED WHEN IT REACHES A DEPTH OF HALF THE HEIGHT OF THE FENCE. THE SILT SHALL BE DISPOSED OF AT AN APPROVED SITE AND IN SUCH A MANNER AS TO NOT CONTRIBUTE TO ADDITIONAL SILTATION.

**EROSION CONTROL DETAILS** 

EACH SIDE SILT FENCE 1 1/2" FILTER ~

FEET IF THERE IS NO APPARENT LOW POINT

SILT FENCE STONE OVERFLOW STRUCTURE

NOTE: STONE OVERFLOW STRUCTURES OF OTHER OUTLET CONTROL DEVICES SHALL BE INSTALLED AT ALL LOW POINTS ALONG THE FENCE OR EVERY 300

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FIRM #: F-3654

SCOTT ATWOOD, PE REG.# 70851

CONSTRUCTION

REVISION SCHEDULE 1 Revise SS alignment to back 2 City Submittal

SHEET NAME

EROSION CONTROL DETAILS

SHEET NO.